09 Visualisation - Exteriors

03 Brunswick Road View Night - south elevation




Town Planning Application 25 February 2025 Project No. 2732



APPENDIX

Pedestrian Foothpath Shadow Study 01

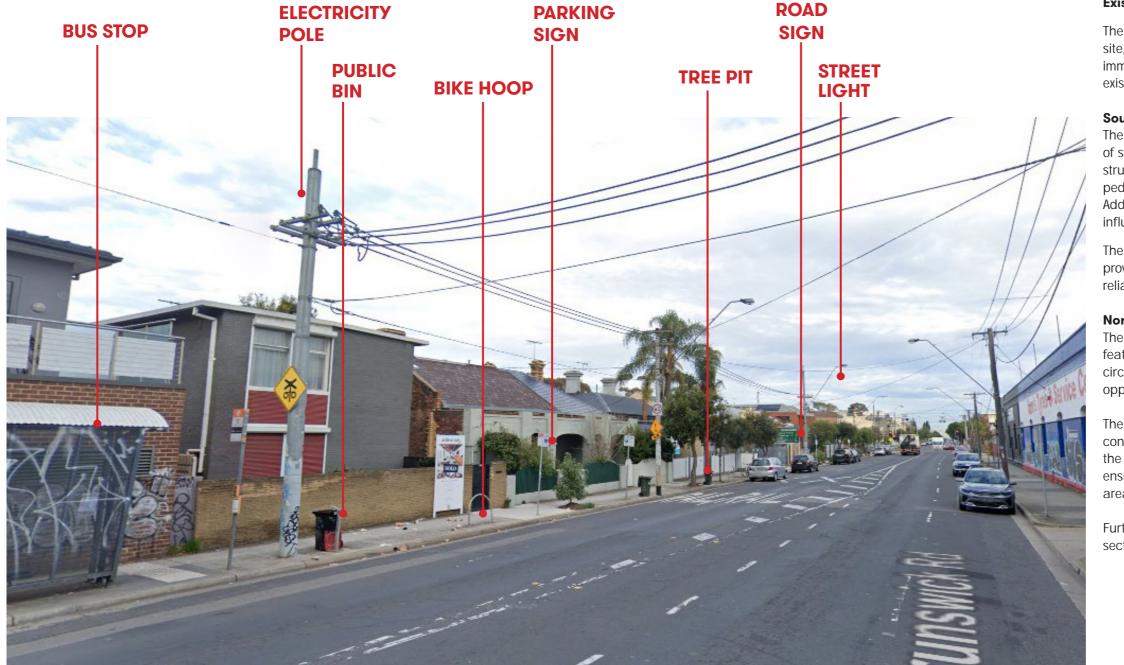

Existing Footpath Character

The footpaths along Brunswick Road, to the north and south of the site, primarily function as minor pedestrian routes within the immediate precinct. Their characteristics and usage di er based on existing street infrastructure and surrounding urban elements.

South

The southern footpath, fronting the site, is characterised by a variety of street furniture and landscaping elements, contributing to a structured yet congested layout. These elements e ectively restrict pedestrian movement to the southern portion of the footpath. Additionally, parking bays are integrated along this strip, further influencing circulation patterns.

The properties along this section are serviced by a rear laneway, providing vehicular access and multiple entry points, minimizing the reliance on front-facing pedestrian access.

North

The northern footpath, directly fronting the site, remains largely featureless and underutilised. Its activation will rely on the pedestrian circulation generated by the proposed development, o ering an opportunity to enhance street-level activity and engagement.


areas.

Town Planning Application 25 February 2025

Project No. 2732

The proposed building form has been designed with careful consideration to minimise shadow impacts on the soluthern section of the footpath. Given its current limited pedestrian activity, the design ensures that any shading does not significantly a ect tra cable

Further details on shadow impact are provided in the following section of this report.

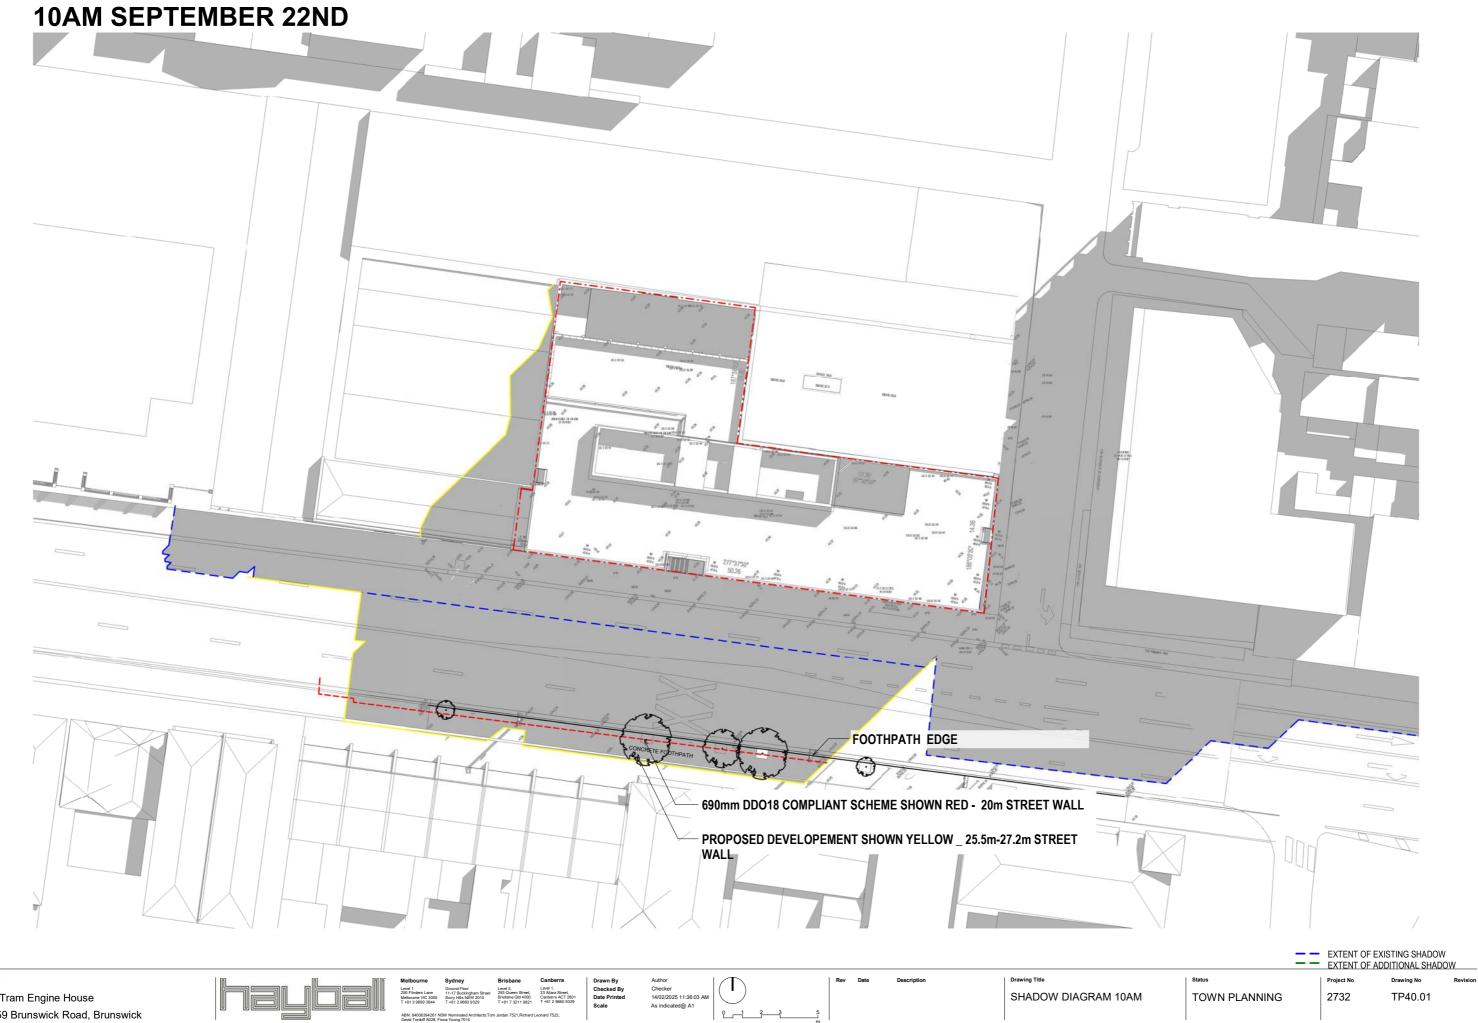

| Project Title | Melbourne Sydney Brisbane Canberra | Drawn By Author | Rev Date Description | Drawing Title |
|--|--|---|----------------------|---------------------|
| Cable Tram Engine House 253-259 Brunswick Road, Brunswick | Log11 Log12 Log13 Log13 Log14 Log14 <td< td=""><td>Checked By Checker Date Printed 14/02/2025 11:36:03 AM Scale As indicated@ A1</td><td></td><td>SHADOW DIAGRAM 10AM</td></td<> | Checked By Checker Date Printed 14/02/2025 11:36:03 AM Scale As indicated@ A1 | | SHADOW DIAGRAM 10AM |

11AM SEPTEMBER 22ND



| Project Title | Melbourne Sydney Br | risbane Canberra | Drawn By | Author | \square | Rev Date | Description | Drawing Title |
|--|---|--|-------------------------------------|---|----------------|----------|-------------|---------------------|
| Cable Tram Engine House 253-259 Brunswick Road, Brunswick | Level 1 Ground Floor 4 250 Finders Lane 11-17 Buckingham Street 29 Melbourne VIC 3000 Surry Hills NSW 2010 Bir 1+61 3 d999 2464 T+612 29609 3329 T + ABN: 84008394261 NSW Nominated Architects.Tom Jord David Tordoff 8028, Fiona Young 7014 | vel 5, Level 1, 3 Queen Street, 33 Allara Street, isbane Qid 4000 Canberra ACT 2801 +61 7 3211 9821 T +61 2 9660 9329 dan 7521,Richard Leonard 7522, | Checked By Date Printed Scale | Checker 14/02/2025 11:36:57 AM As indicated@ A1 | 0 1 2 3 5 m | | | SHADOW DIAGRAM 11AM |

12PM SEPTEMBER 22ND



| Project Title | Melbourne Sydney Brisbane Canberra | Drawn By Author | \square | Rev Date Descrip | ption Drawing Title |
|--|--|---|-----------|------------------|---------------------|
| Cable Tram Engine House 253-259 Brunswick Road, Brunswick | Level 1. Level 1. Level 5. Level 5. Level 5. Level 5. Level 5. 200 Finders Level 5. Third Reschargham Street 283 Queen Street, 33 Alarvas Street Methodener V/C 3000 Sumy His IsS/V2 2010 Bindamer QL4 000 Carbiera ACT 1r41 396959342 dt 1r41 272 1962 T 1r41 275 1962 T 1r4 | Checked By Checker Date Printed 14/02/2025 11:38:10 AM Scale As indicated@ A1 | | | SHADOW DIAGRAM 12PM |

1PM SEPTEMBER 22ND



| Project Title | Melbourne Sydney Brisbane Canberra | Drawn By Author | Rev Date Description | Drawing Title |
|--|--|---|----------------------|--------------------|
| Cable Tram Engine House 253-259 Brunswick Road, Brunswick | Level 1 Ground Floor Level 5, Level 1, Level 5, Level 1, Level 5, Matea Street, Matea Street, | Checked By Checker Date Printed 14/02/2025 11:38:38 AM Scale As indicated@ A1 | 5 m | SHADOW DIAGRAM 1PM |

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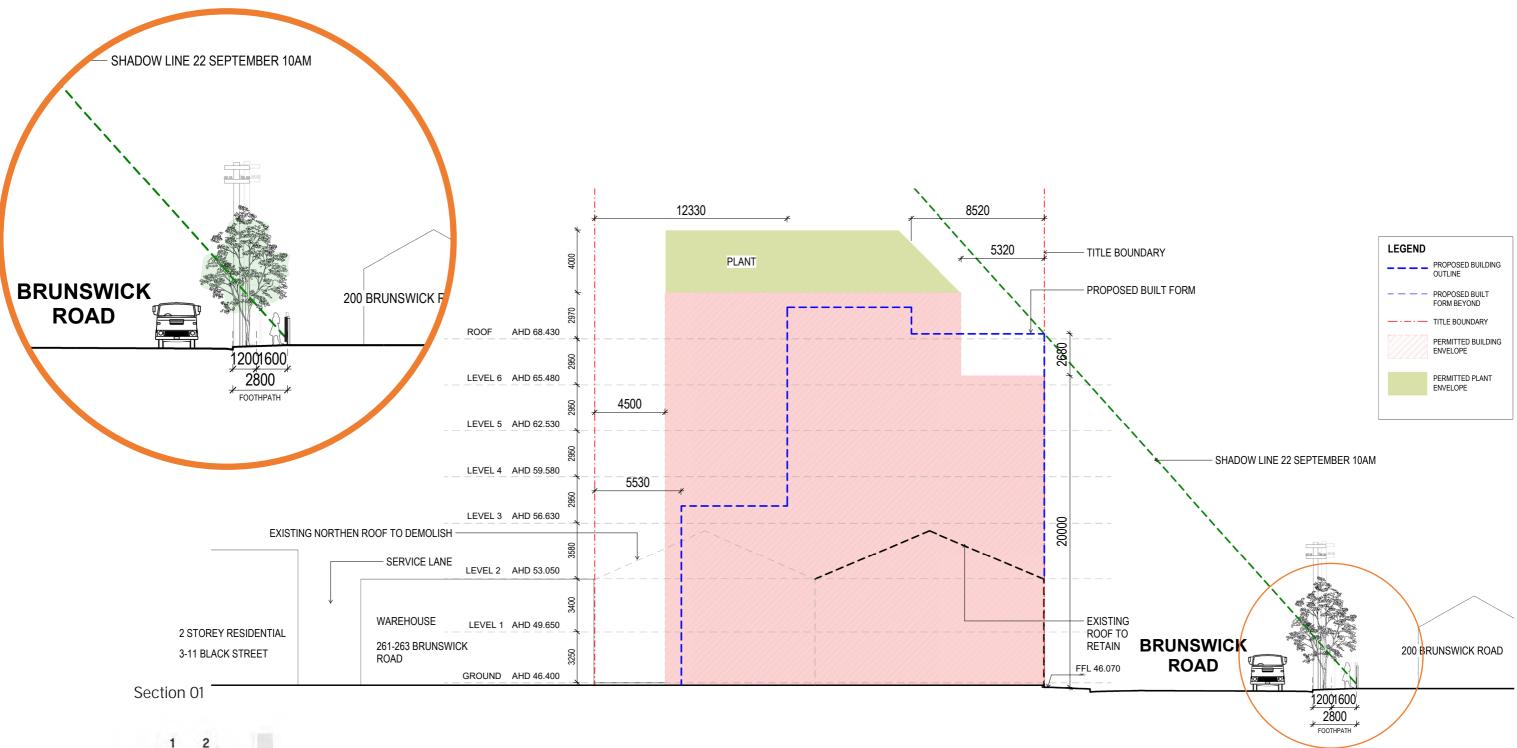
2PM SEPTEMBER 22ND





| Project Title | Melbourne Sydney | Brisbane Canberra | Drawn By | Author | \square | Rev Date | Description | Drawing Title |
|--|--|---|-------------------------------------|---|-----------|----------|-------------|--------------------|
| Cable Tram Engine House 253-259 Brunswick Road, Brunswick | Level 1 Ground Floor 250 Finders Lane 11-17 Buckingham Street Melbourne VIC 3000 Surry Hills NSW 2010 1+613 9969 324 1+612 9669 9329 ABN: 84005394261 NSW Nominated Architects: Ton David Tordolf 8028, Fiona Young 7014 | Level 5, Level 1, 293 Queen Street, 33 Allara Street, Brisbane Qid 4000 Canberra ACT 2601 T +61 7 3211 9821 T +61 2 9660 9329 n Jordan 7521,Richard Leonard 7522, | Checked By Date Printed Scale | Checker 14/02/2025 11:39:54 AM As indicated@ A1 | | | | SHADOW DIAGRAM 2PM |

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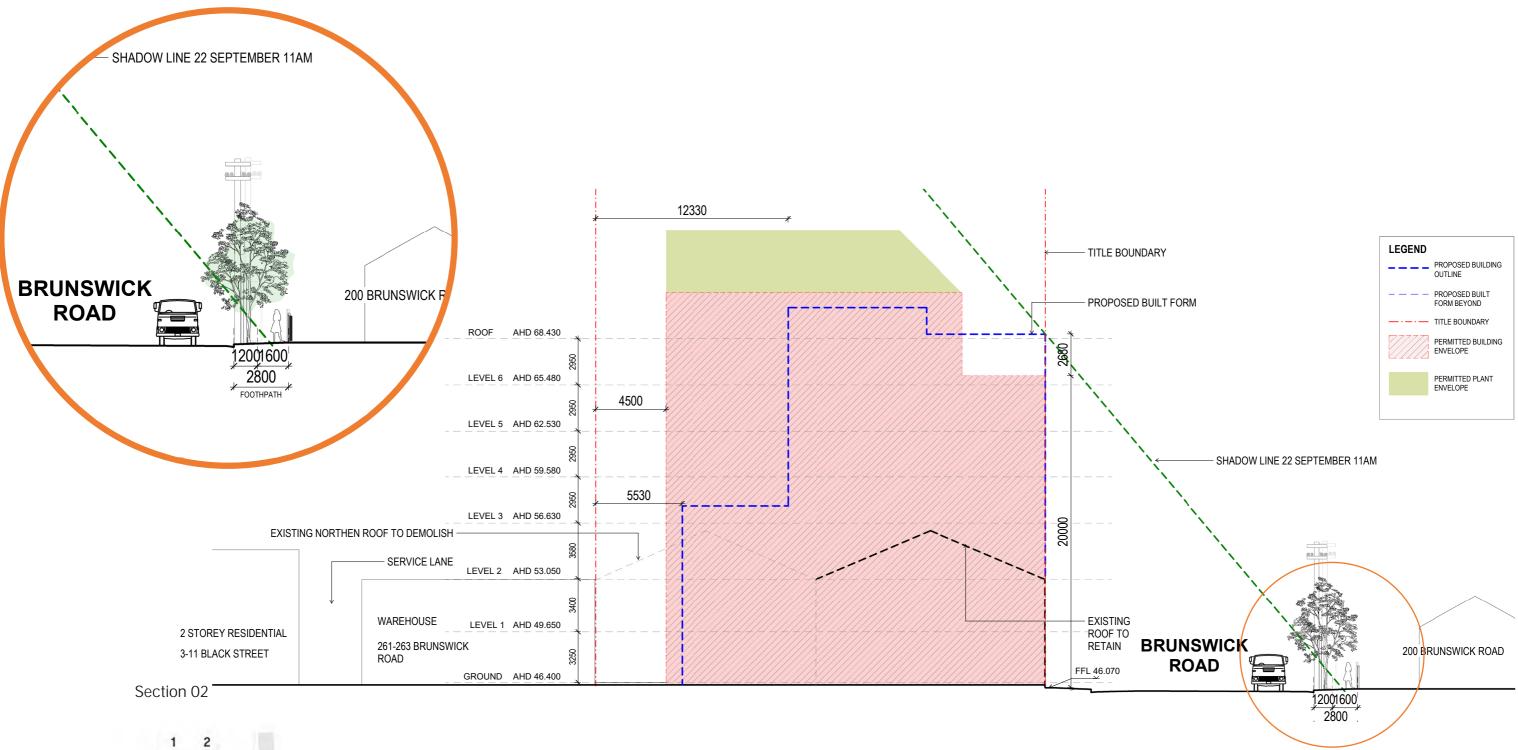
Pedestrian Foothpath Shadow Study North / South Section 10AM 01






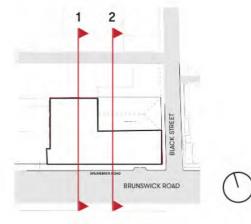

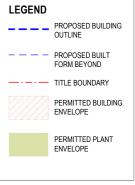Pedestrian Foothpath Shadow Study North / South Section 11AM 02



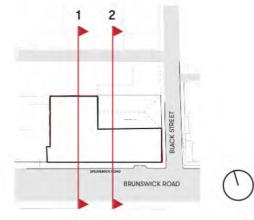


Southern Footpath Shadow - 3D Studies 03


The limited encroachment of shadow at mid morning on the southern footpath, opposite the site along Brunswick Road, represents minimal loss of amenity to pedestrians as demonstrated in these 3D studies.

At ground plane, the shadow fully shifts o the usable section of the footpath in an hour.


The angle of shadow does not impinge daylight casting on pedestrians in a way that is any greater than existing street furniture or vegetation.

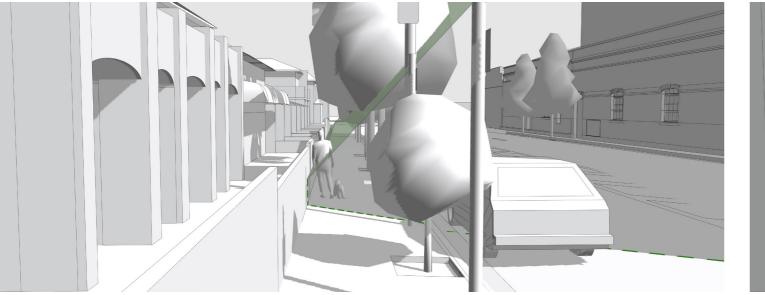


3D SHADOW STUDY - 10 AM

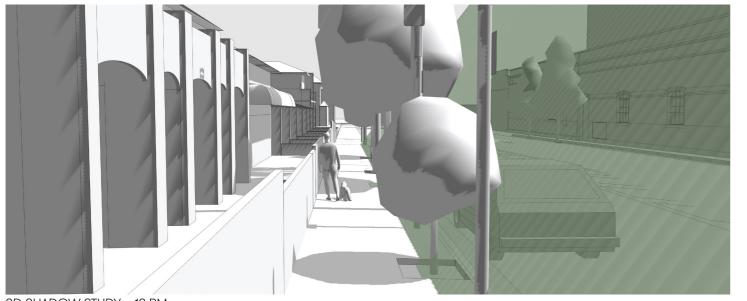


3D SHADOW STUDY - 12 PM

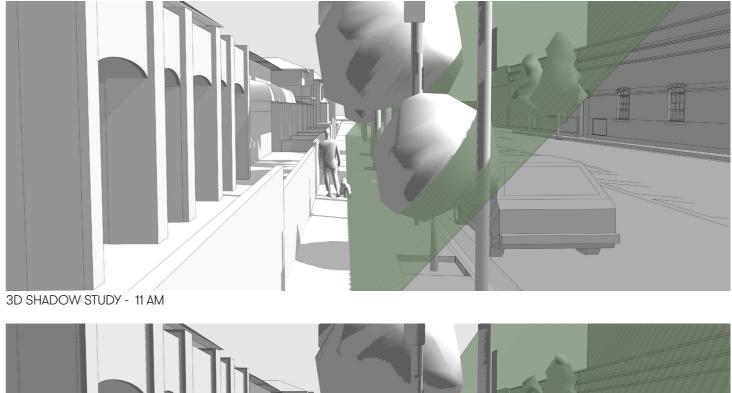

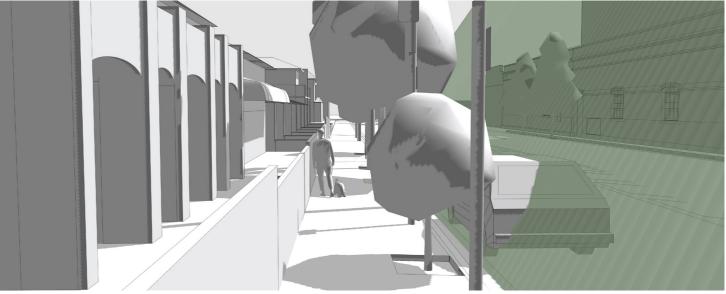


3D SHADOW STUDY - 1 PM

O1 Plans

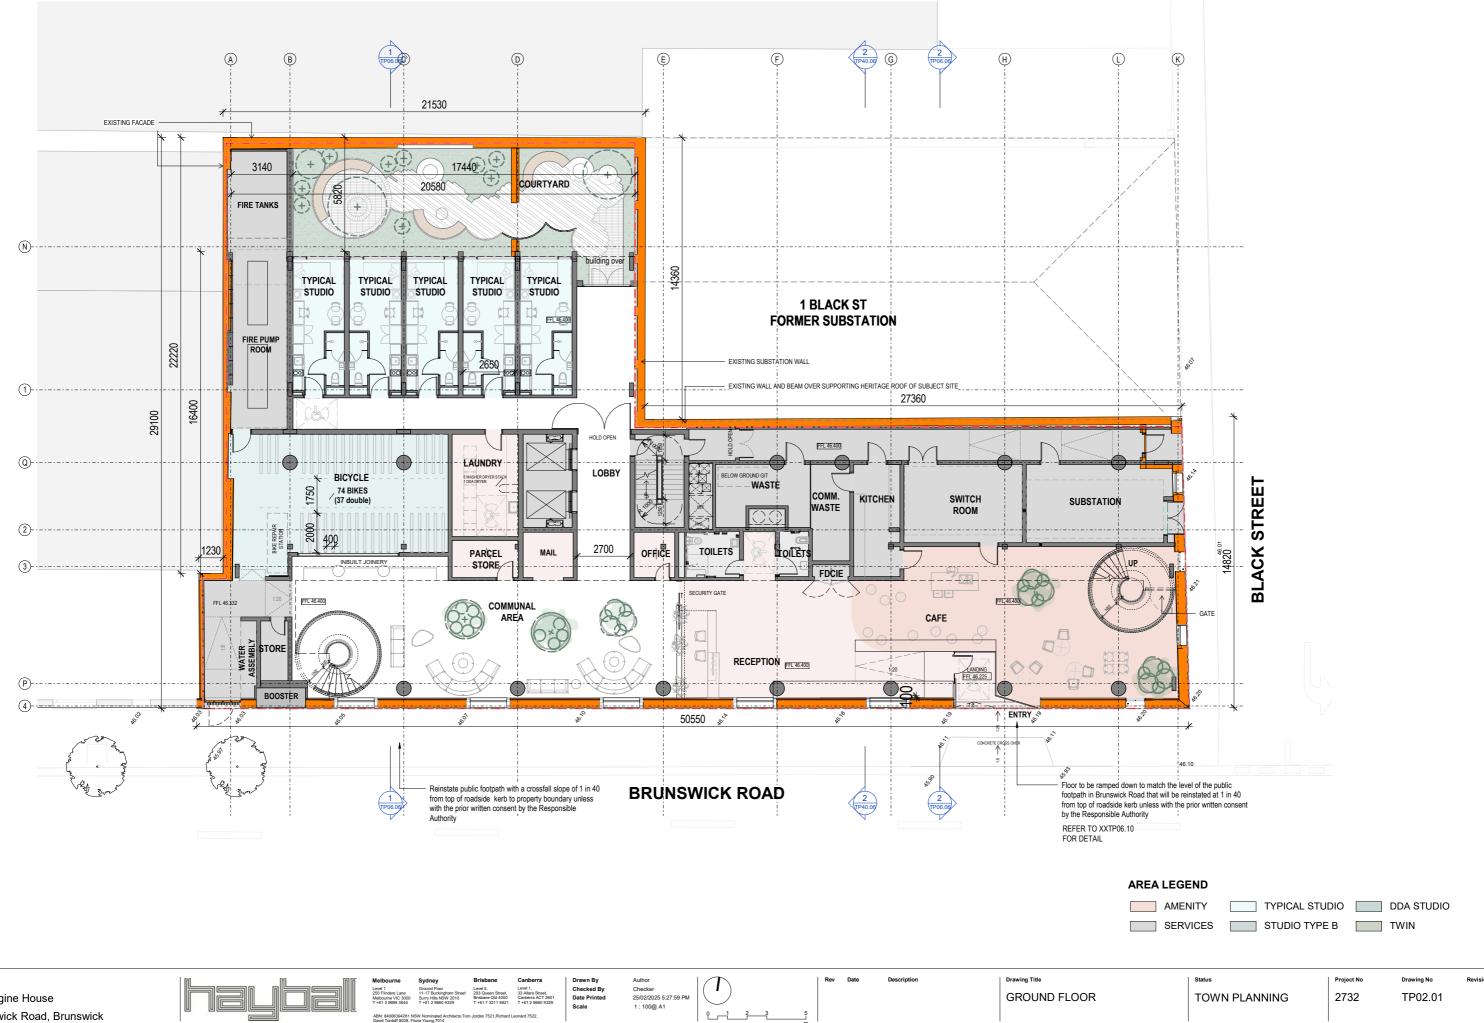




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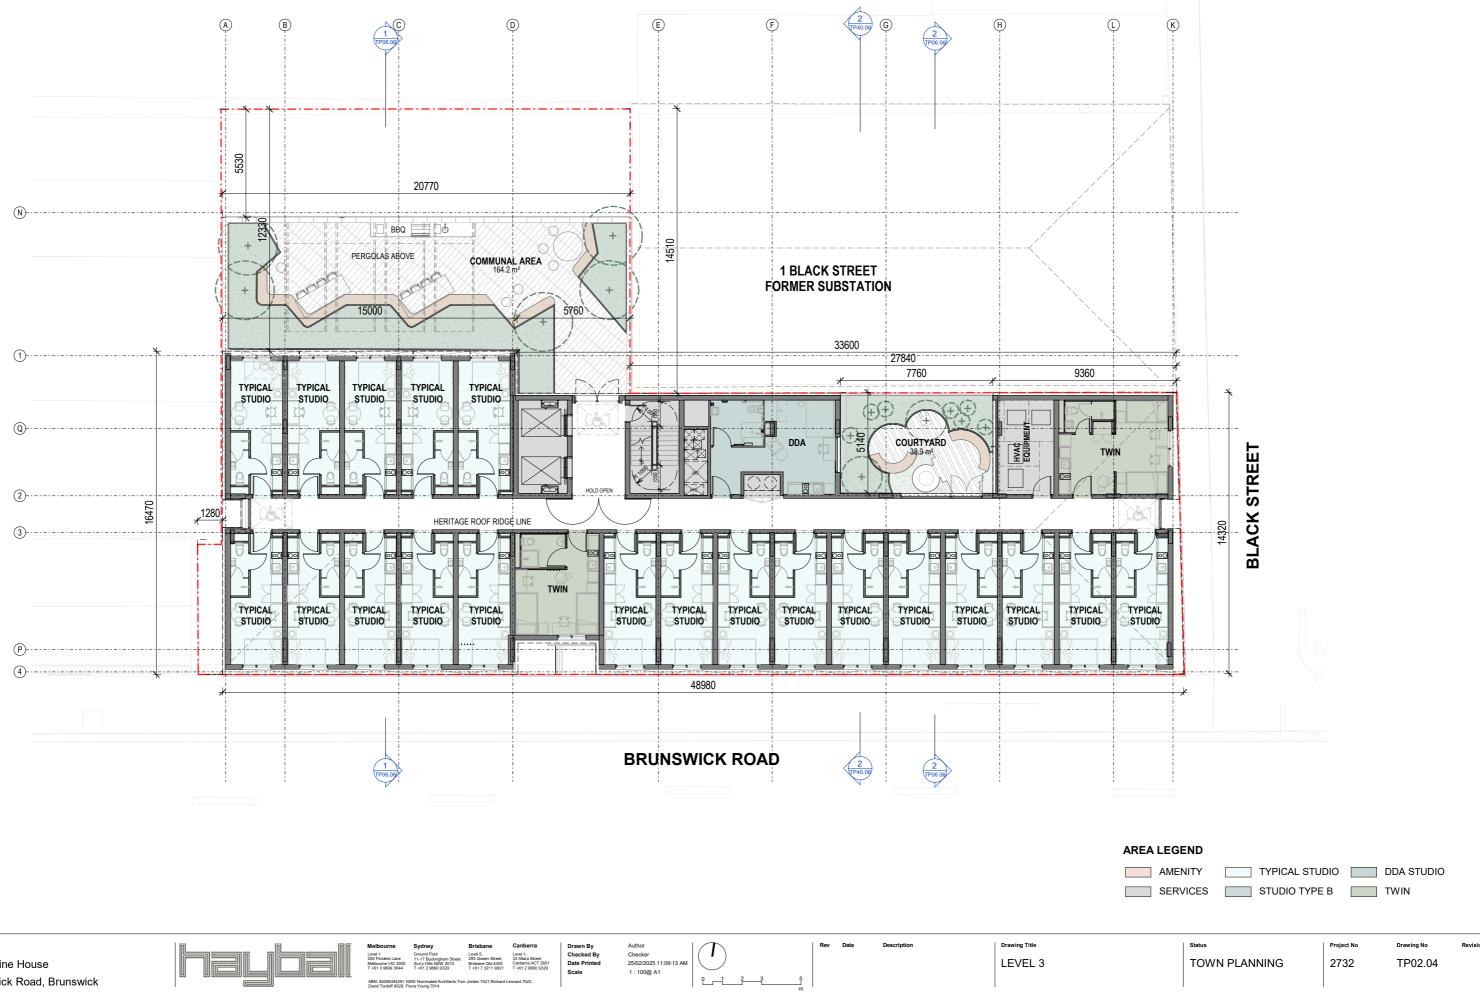


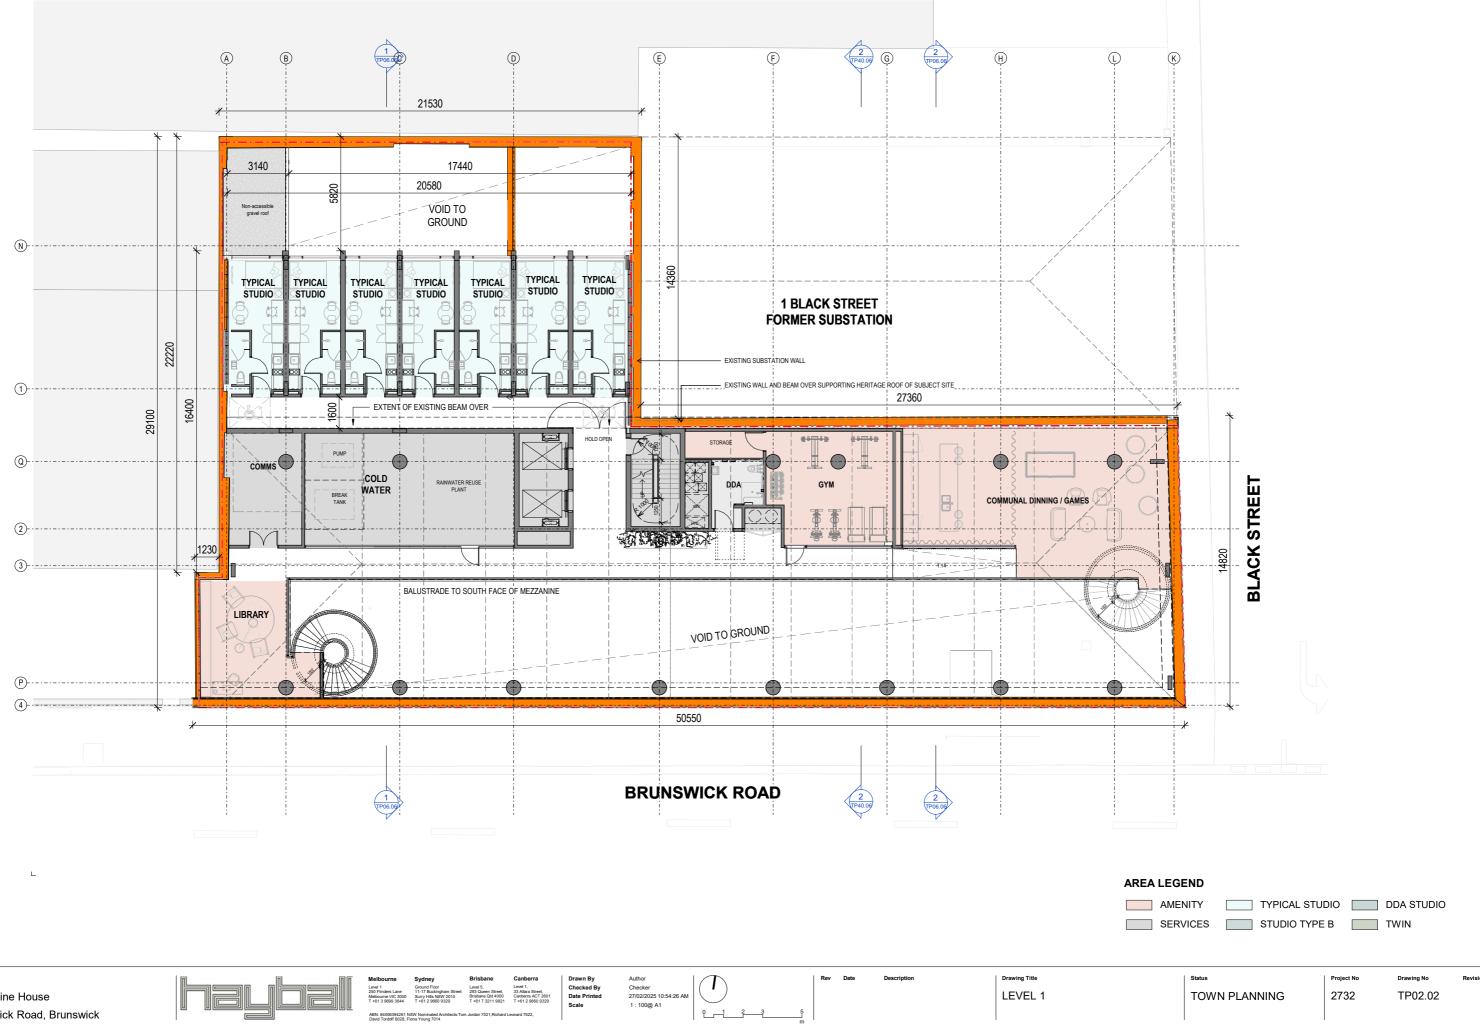



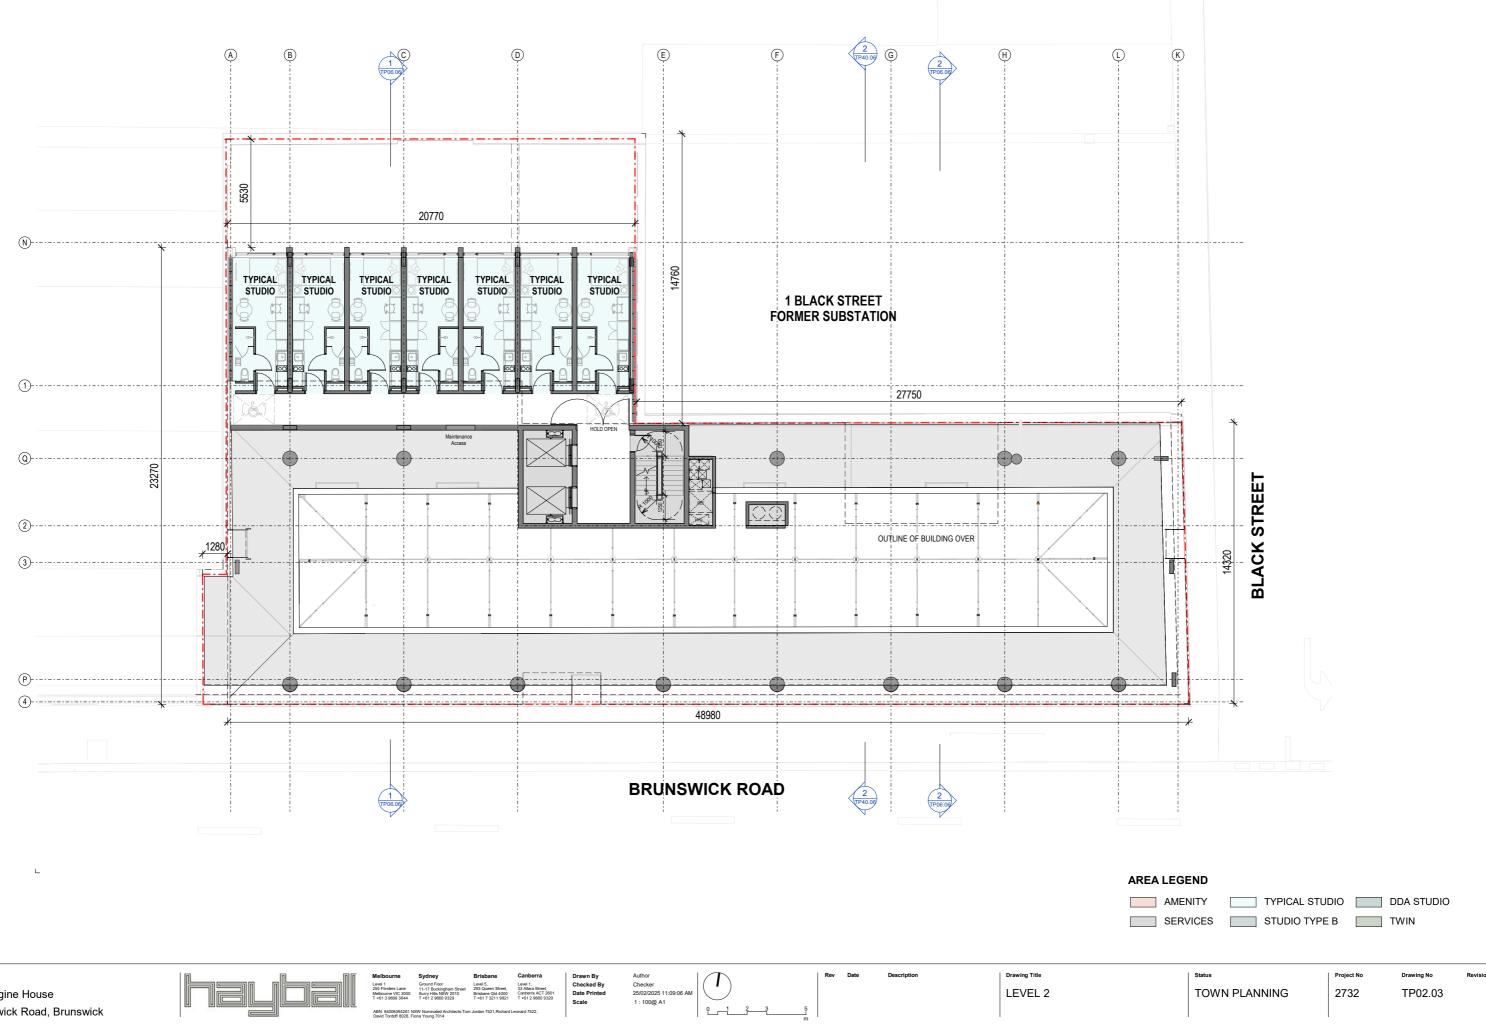


Builders/Contractors shall verify job dimensions before any job con © Copyright 2008 All rights reserved ences. Figured dimensions shall take precedence over scaled work.Work shall also conform to the specification wings and job dimensions. All shop drawings shall be submitted to the Archite ence prior to the return of inspected shop drawings signed by the Archite ains copyright and grants the client a licence to use the Design for the purp




| Project Title | Melbourne | Sydney Ground Floor | Brisbane | Canberra | Drawn By Checked By | Author | \frown | Rev Date | Description | Drawing Title |
|--|---|--|---|---|-------------------------------------|--|----------------|----------|-------------|---------------|
| Cable Tram Engine House 253-259 Brunswick Road, Brunswick | Level 1 250 Flinders Lane Melbourne VIC 3000 T +61 3 9699 3644 ABN: 84006394261 NS David Tordoff 8028, Fic | 11-17 Buckingham Street Surry Hills NSW 2010 T +61 2 9660 9329 | 293 Queen Street, Brisbane Qid 4000 T +61 7 3211 9821 | 33 Allara Street, Canberra ACT 2601 T +61 2 9660 9329 | Checked By Date Printed Scale | Checker 25/02/2025 11:09:13 AM 1 : 100@ A1 | 0 1 2 3 5 m | | | LEVEL 3 |

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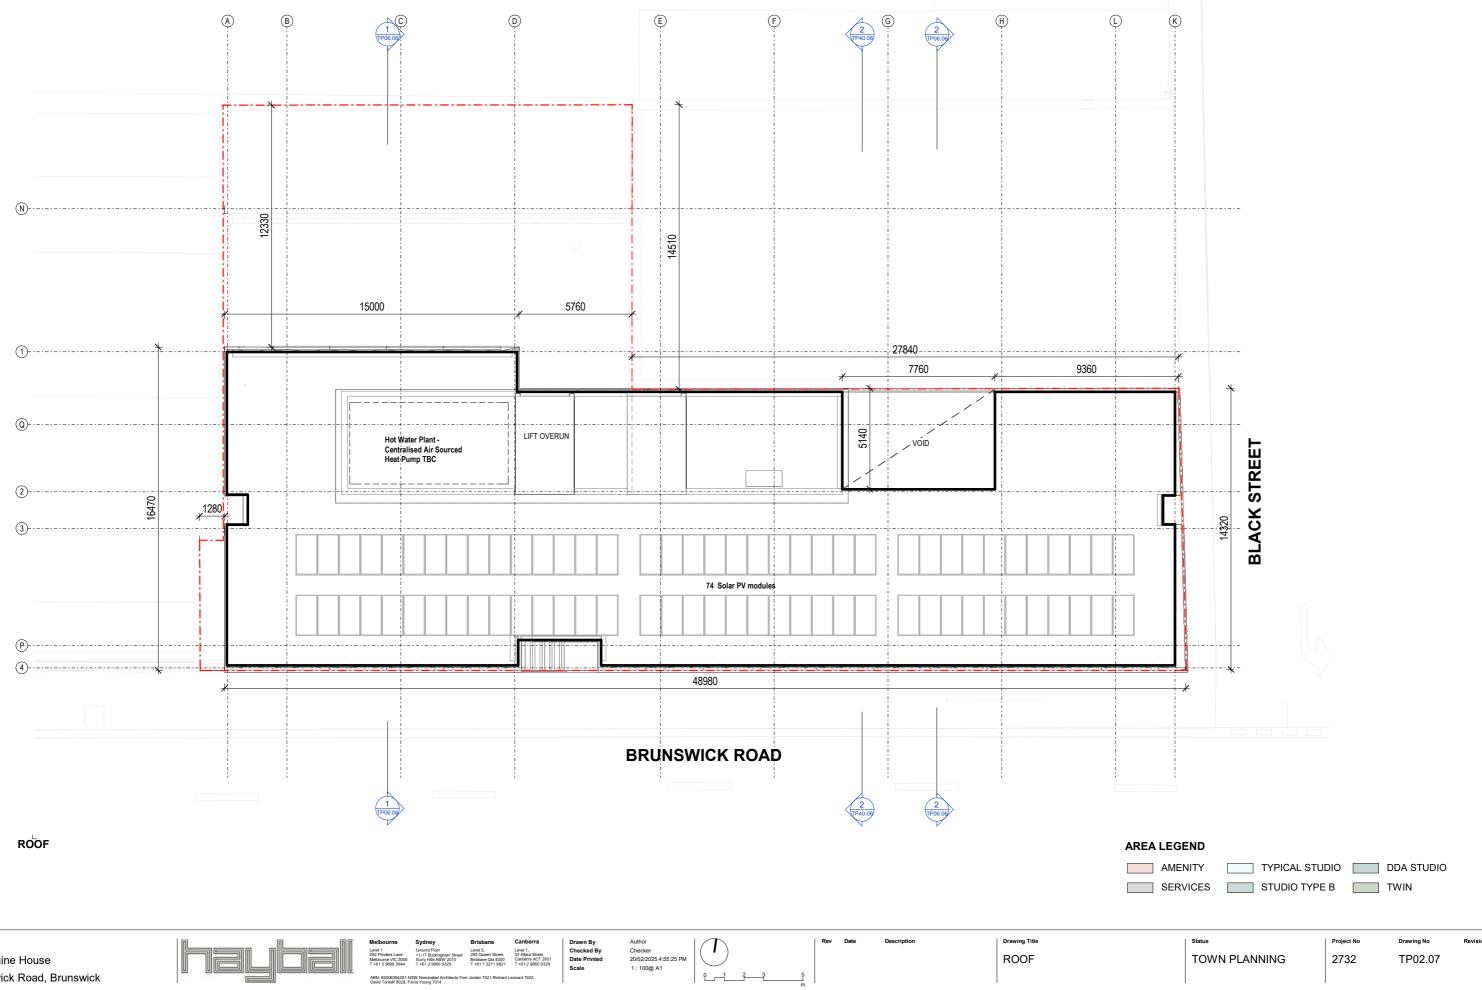


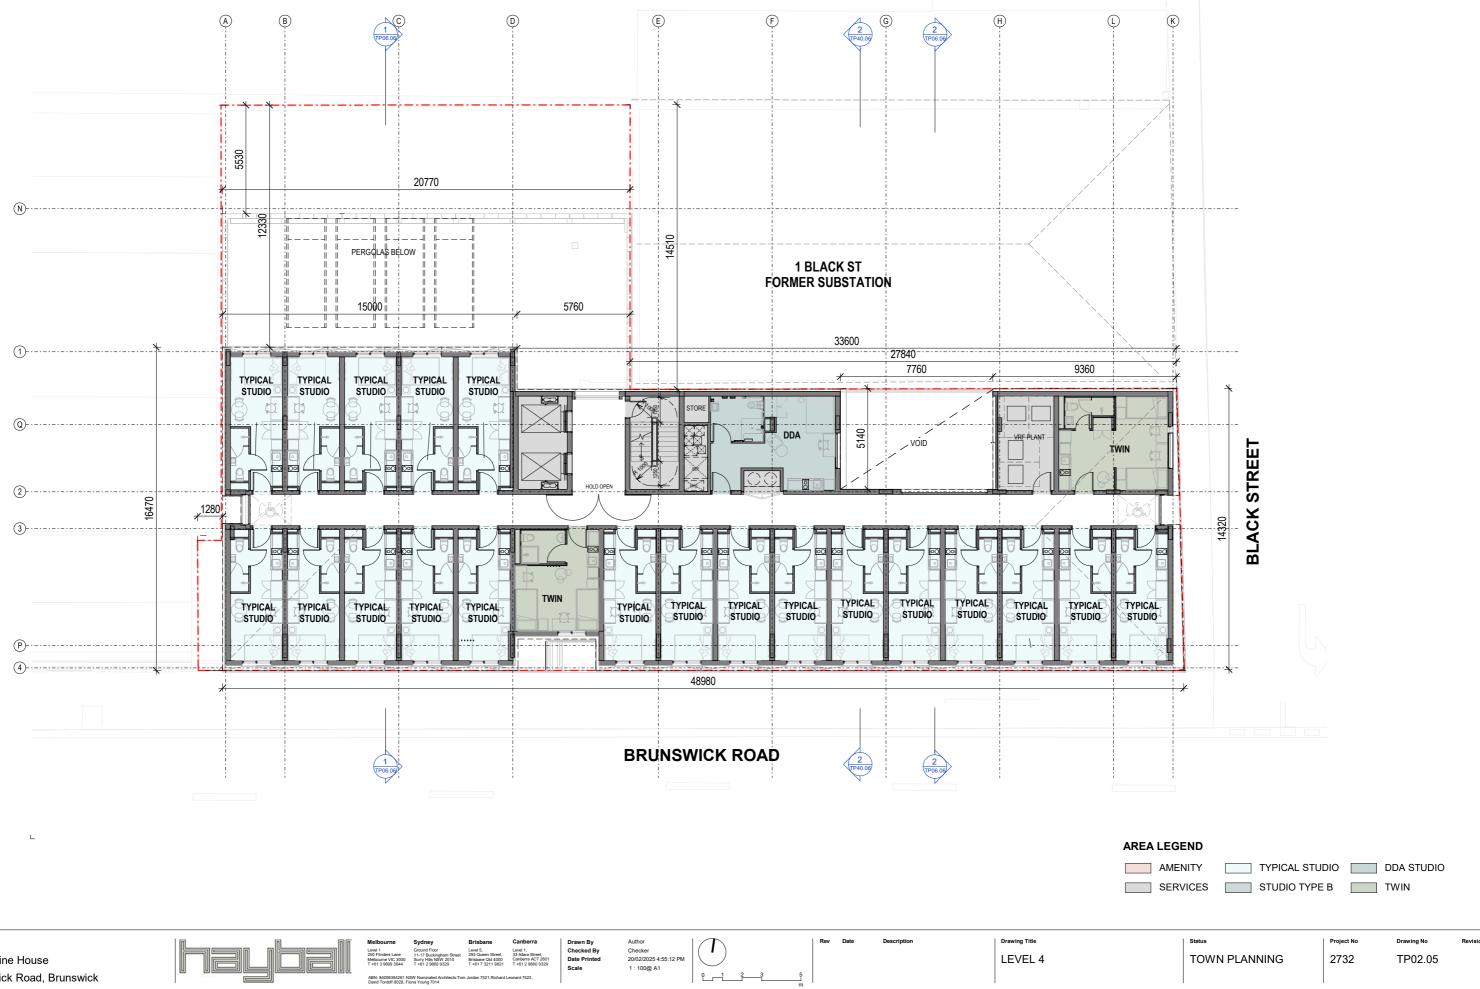sions.All shop drawings shall be sub Builders/Contractors shall verify job dimensions before any job co © Copyright 2008 All rights reserved ed shop drawings signed by the Ar ces. Figured dim



| Project Title Cable Tram Engine House 253-259 Brunswick Road, Brunswick | helle | Melbourn Level 1 250 Filndes Melbourne VI T +61 3 9699 ABN: 840063 David Tordelf | Brisbane Level 5, et 293 Queen Street, Brisbane Old 4000 T +61 7 3211 9821 Tom Jordan 7521, Richard | Canberra Level 1, 33 Alfara Street, Canberra ACT 2801 T +61 2 9860 9329 Leonard 7522, | Drawn By Checked By Date Printed Scale | Author Checker 20/02/2025 4:55:20 PM 1 : 100@ A1 | 5 | Rev | Date | Description | Drawing Title LEVEL 5-6 TYP | ICAL |
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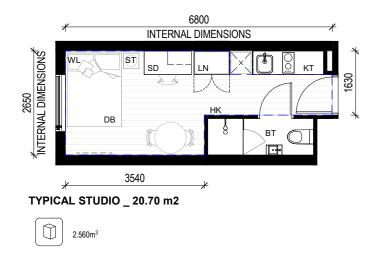
Builders/Contractors shall verify job dimensions before any job c © Copyright 2008 All rights reserved ions All shop drawings shall be submitted to the Architect/Consultant and manufacture shall not commence prior to the return of inspected shop drawings signed by the Architect/Consultant.Hayball retains copyright and grants the client a licence to use the Design for the pun tion, other drawings and job dimer

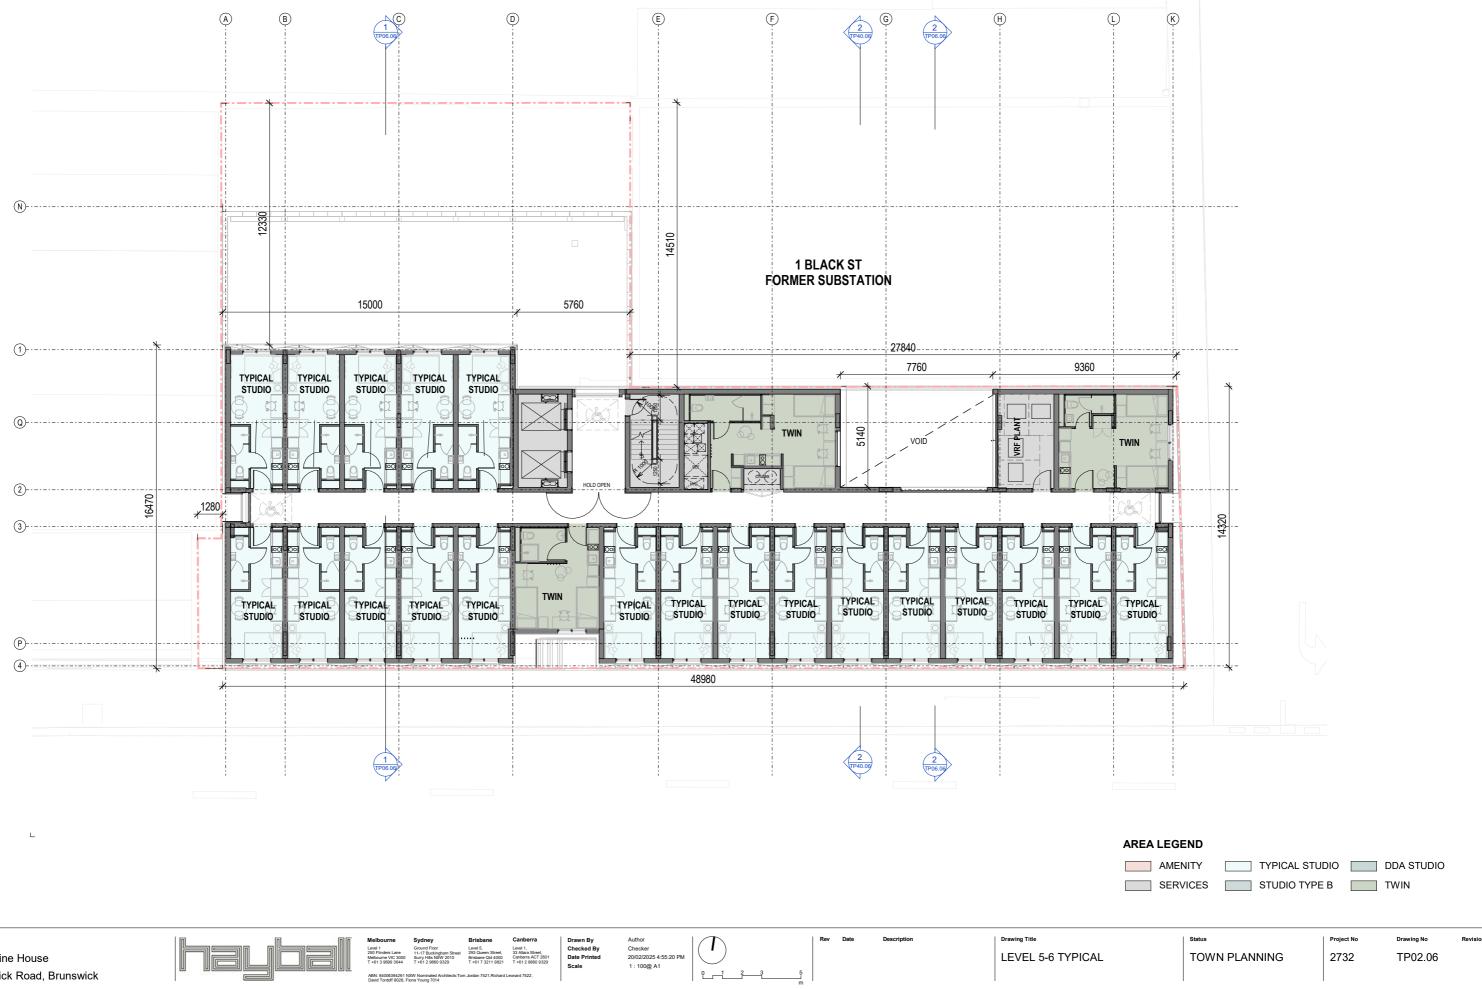


Project Title Cable Tram Engine House 253-259 Brunswick Road, Brunswick

Builders/Contractors shall verify job dimensions before any job commences. Figured dimensions shall take precedence over scaled work Work shall also conform to the specification, other drawings and job dimensions. All shop drawings shall be submitted to the Architect/Consultant and manufacture shall not commence prior to the return of inspected shop drawings signed by the Architect/Consultant © Copyright 2008 All rights reserved Hayball retains copyright and grants the client a licence to use the Design for the purposes of this project, but only for the particular stages of ser


STUDIO




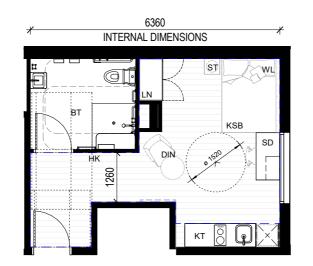

DDA STUDIO _ 31.8 m2 \square

TWIN

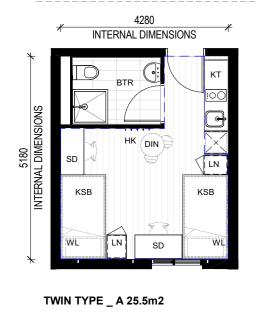


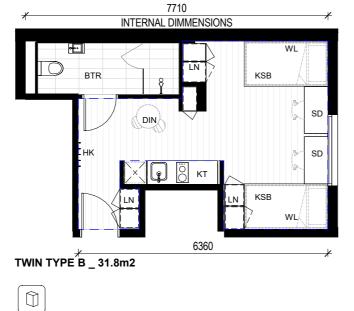





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NOTE: FOR BADS STORAGE CALCULTIONS 1. 2700MM AFFL GENERAL HEIGHTS 2. 2400MM CEILING HEIGHT 3. 760MM HIGH UNDERBENCH STORAGE

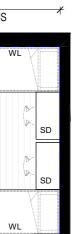- 760MM HIGH UNDERBENCH STORAG 800MM HIGH ON OHEAD STORAGE 600M BENCHTOP DEPTH 100 MM DEEP SPICE RACKS 150 H DRAWER UNDER OVEN 5
- 6.

ABBREVIATIONS

- BT DB HK KSB KT

- REVIATIONS : PRIVATE ENSUITE BATHROOM : DOUBLE BED : CLOTHES HOOK : KING SINGLE : KITCHENTETE WITH MICROWAVE, 2- BURNER STOVE, DRAWER DISCHWASHER/DISHWASHER AND FULL HEIGHT FRIDGE : BUILT.IN WARDROBE WITH FULL LENGTH MIRROR : QUEEN BED : STUDY DESK WITH BOOKSHELF AND CHAIR 1200mm UNLESS OTHERWISE DIMENSIONED : NBUILT.SIDE TABLE : WALL MOUNTED LIGHT FITTING
- LN QB SD

- ST WL

TOWN PLANNING


Status

Project No 2732

Drawing No TP10.01


Plans 01

01 Entry Levels Diagram

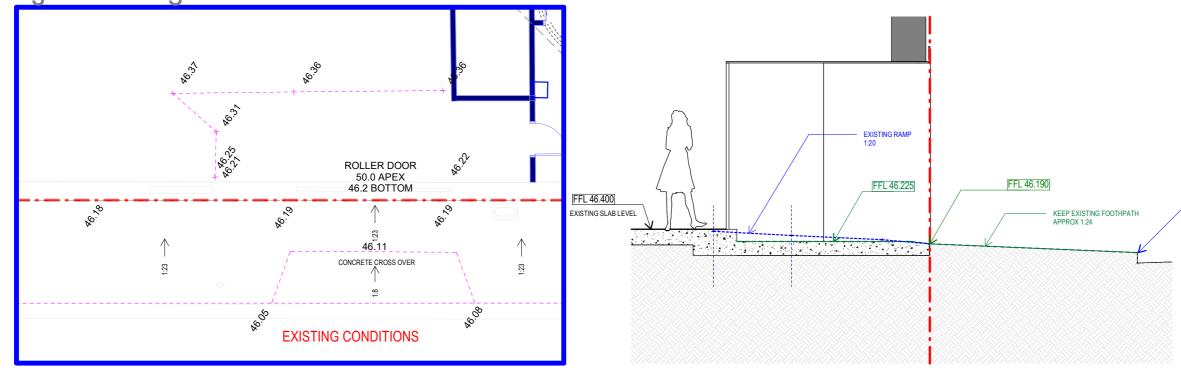

GROUND FLOOR - ENTRY LEVELS EXISTING

ENTRY LEVELS DETAIL SECTION

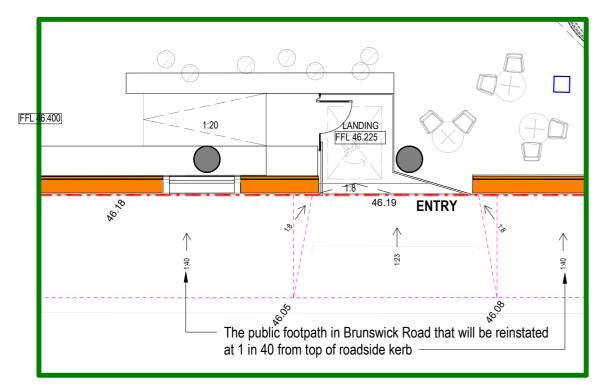

GROUND FLOOR - ENTRY LEVELS NEW DESIGN

| Project Title Cable Tram Engine House | haubail | Level 1 ,250 Flinders Lane Melbourne VIC 3000 T +61 3 9699 3644 | Sydney 11-17 Buckingham Street Surry Hills NSW 2010 T +61 2 9660 9329 | Brisbane Level 5,293 Queen Street, Brisbane Qld 4000 T +61 7 3211 9821 | Canberra Level 1, 33 Allara Street, Canberra ACT 2601 T+61 2 9660 9329 | Date Printed Time Scale | 14/02/2025 1:01:42 PM As indicated@ A3 | 1.6 2.4 | 4 | Rev Date | Description | S L |
|--|---------|---|--|---|---|-------------------------------|--|---------|--------|----------|-------------|--------|
| 253-259 Brunswick Road, Brunswick | | ABN: 84006394261 NSW Nomir Fiona Young 7014 | nated Architects:Tom Jordar | n 7521,Richard Leonard 7522, E | avid Tordoff 8028, | | | | j m | | | |

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| | prior to the areas, dime and setouts thereof, are are subject that the infor representat either expre purchasers All areas, ni whole numi | completion of cc insions, fittings, , and the like, a indicative only, to change withd rmation presen ion ofthe final p issly or implied. must rely on th umbers are roun ber. ons are approxir ' external furnitu | roduct is not given Prospective eir own enquiries. nded to the nearest |
|---|---|--|---|
| Drawing Title SECTION DIAGRAMS -ENTRY LEVELS FOR REPORT | , Project No 2732 | Drawing No XXTP06.1 | Revision O |

AVERAGE TOP OF ROADSIDE KERB

O2 Existing & Proposed Elevations



EXISTING SOUTH ELEVATION



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BLACK STREET

BR01 CON1 GL01 MT01 MT02 MT03 MT04 LV01 ST01

MATERIAL LEGEND

| BRICKWORK EXISTING |
|---|
| PRECAST CONCRETE COLOURED |
| CLEAR GLAZING IN CHARCOAL FINISH FRAMES |
| METAL CLADDING - PERFORATED |
| METAL FINISH WINDOW FRAMES - CHARCOAL |
| METAL BATTEN DOORS / FRAMES |
| EXISTING ROOF FINISH |
| METAL LOUVRE |
| BLUESTONE EXISTING |

TOWN PLANNING

Project No 2732 Drawing No TP06.02



EXISTING EAST ELEVATION ROOF SS AHD 74.350 2950 14440 8520 ROOF SSS AHD 71.400 2970 -MT01 68.750 SERVICES / PLANT ZONE ROOF AHD 68.430 2950 -MT01 L01 LEVEL 6 AHD 65.480 2950 MT01 BUILDING BEYOND LEVEL 5 AHD 62.530 2950 MT01 LEVEL 4 AHD 59.580 950 MT01 22300 LEVEL 3 AHD 56.630 MT01 580 LEVEL 2 AHD 53.050 (BR01) 3400 LEVEL 1 AHD 49.650 BRUNSWICK ROAD 3250 ST01 GROUND AHD 46.400 EAST ELEVATION -BLACK STREET Project Title Drawn By Checked By Date Printed Scale Author Checker 27/02/2025 5:20:37 PM 1 : 100@ A1 Drawing Title Canberra Level 5, Level 1, 293 Queen Street, 33 Alara Street, Brisbane Qld 4000 Canberra ACT 2601 T +61 7 3211 9821 T +61 2 9660 9329 Level 1 250 Eli Ground Floor 11-17 Buckingham Street ne VIC 3000 Surry Hills NSW 2010 9699 3644 T +61 2 9660 9329 **ELEVATIONS - EAST** Cable Tram Engine House

ABN: 84006394261 David Tordoff 8028

253-259 Brunswick Road, Brunswick

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2___3

EXISTING ADJACENT TRAM SUBSTATION BUILDING (1 BLACK STREET)

MATERIAL LEGEND

| BR01 | BRICKWORK EXISTING |
|------|---|
| CON1 | PRECAST CONCRETE COLOURED |
| GL01 | CLEAR GLAZING IN CHARCOAL FINISH FRAMES |
| MT01 | METAL CLADDING - PERFORATED |
| MT02 | METAL FINISH WINDOW FRAMES - CHARCOAL |
| MT03 | METAL BATTEN DOORS / FRAMES |
| MT04 | EXISTING ROOF FINISH |
| LV01 | METAL LOUVRE |
| ST01 | BLUESTONE EXISTING |
| | |

EXISTING ADJACENT SUBSTATION BUILDING (1 BLACK STREET)

- REINSTATE EXISTING DOORWAY


REINSTATE EXISTING WINDOW

Status

TOWN PLANNING


Project No 2732 Drawing No TP06.03

Revision

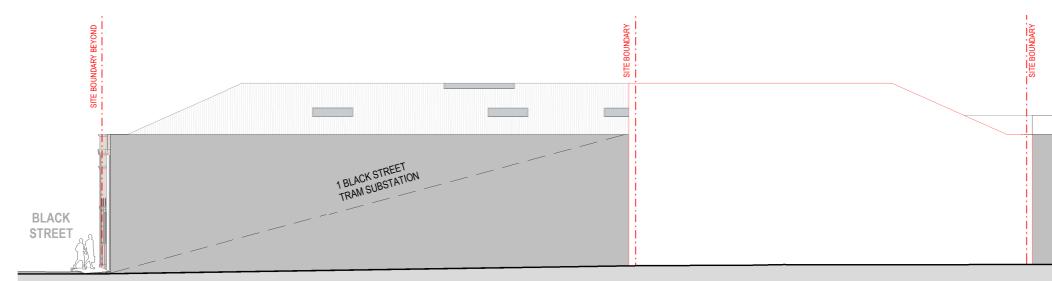

EXISTING NORTH ELEVATION


253-259 Brunswick Road, Brunswick

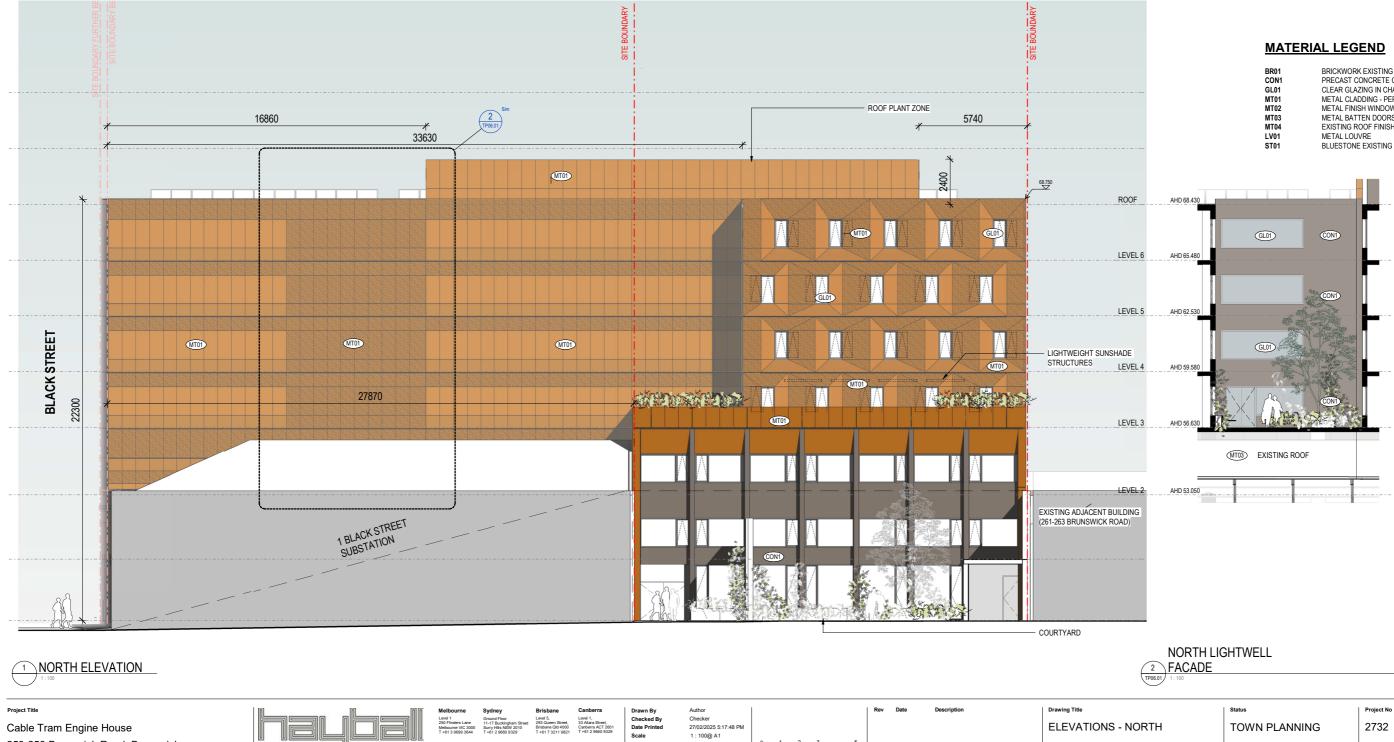

<u>L-1</u>

2___3


ABN: 84006394261 NS David Tordoff 8028 Fig

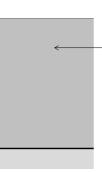


- EXISTING ADJACENT BUILDING (261-263 BRUNSWICK ROAD)

| BR01 | BRICKWORK EXISTING |
|------|---|
| CON1 | PRECAST CONCRETE COLOURED |
| GL01 | CLEAR GLAZING IN CHARCOAL FINISH FRAMES |
| MT01 | METAL CLADDING - PERFORATED |
| MT02 | METAL FINISH WINDOW FRAMES - CHARCOAL |
| MT03 | METAL BATTEN DOORS / FRAMES |
| MT04 | EXISTING ROOF FINISH |
| LV01 | METAL LOUVRE |
| ST01 | BLUESTONE EXISTING |

| Status | Project No | Drawing No | Revision |
|---------------|------------|------------|----------|
| TOWN PLANNING | 2732 | TP06.01 | |
| TOWN PLANNING | 2732 | TP06.01 | |

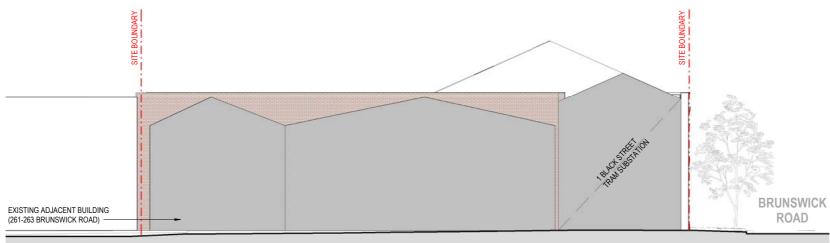

EXISTING WEST ELEVATION

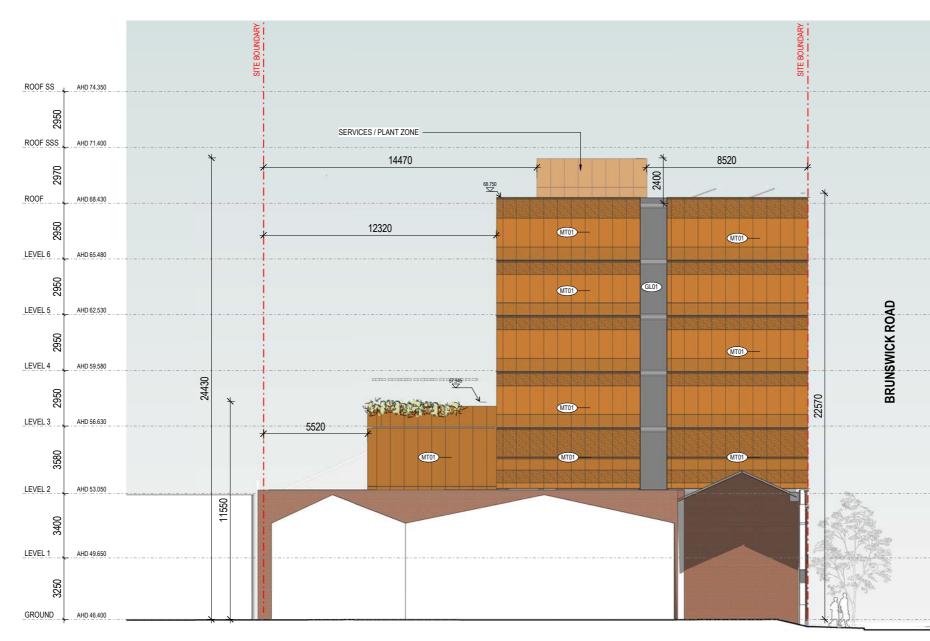

ons shall take

| Project Title | Melbourne Sydney | Brisbane Canberra | Drawn By | Author | | Rev Date | Description | Drawing Title |
|--|---|--|-------------------------------------|---|---|----------|-------------|-------------------|
| Cable Tram Engine House 253-259 Brunswick Road, Brunswick | Level 1 Ground Floor 250 Finders Lane Melbourne VIC 3000 T +61 3 9699 3444 T +61 2 9680 9329 | reet 293 Queen Street, 33 Allara Street, Brisbane Qid 4000 Canberra ACT 2601 T +61 7 3211 9821 T +61 2 9660 9329 | Checked By Date Printed Scale | Checker 28/02/2025 9:18:48 AM 1 : 100@ A1 | | | | ELEVATIONS - WEST |
| | David Tordoff 8028, Fiona Young /014 | | 1 | | m | 1 | | I |

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MATERIAL LEGEND

| BR01 | BRICKWORK EXISTING |
|------|---|
| CON1 | PRECAST CONCRETE COLOURED |
| GL01 | CLEAR GLAZING IN CHARCOAL FINISH FRAMES |
| MT01 | METAL CLADDING - PERFORATED |
| MT02 | METAL FINISH WINDOW FRAMES - CHARCOAL |
| MT03 | METAL BATTEN DOORS / FRAMES |
| MT04 | EXISTING ROOF FINISH |
| LV01 | METAL LOUVRE |
| ST01 | BLUESTONE EXISTING |
| | |

TOWN PLANNING

Status

Project No 2732

Drawing No TP06.04 Revisio

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03 Sections