GENERAL

- G1 THE STRUCTURAL DRAWINGS SHALL BE READ IN CONJUNCTION WITH ALL RELEVANT ARCHITECTURAL AND OTHER CONSULTANTS DRAWINGS, SPECIFICATIONS AND ANY WRITTEN INSTRUCTIONS ISSUED DURING THE COURSE OF THE CONTRACT. DISCREPANCIES SHALL BE REFERRED TO THE ENGINEER FOR DECISION BEFORE PROCEEDING WITH WORK.
- G2 DIMENSIONS SHALL NOT BE OBTAINED BY SCALING THE STRUCTURAL DRAWINGS.
- G3 SUBSTITUTES WILL NOT BE PERMITTED WITHOUT THE WRITTEN APPROVAL OF THE ENGINEER.
- G4 DURING CONSTRUCTION THE STRUCTURE SHALL BE MAINTAINED IN A STABLE CONDITION AND NO PART OF THE STRUCTURE SHALL BE OVERSTRESSED AS A RESULT OF THE CONSTRUCTION PROCEDURE. TEMPORARY WORKS Eg ALL PROPPING, FORMWORK NEEDLING AND PROPPING AND ALL HANDLING OPERATIONS SHALL BE THE RESPONSIBILITY OF THE BUILDER. WHERE THESE ACTIVITIES ARE MORE THAN ROUTINE CONVENTIONAL PRACTICE, THE BUILDER SHALL ENGAGE A RBP ENGINEER TO PROVIDE A CERTIFIED DESIGN FOR REVIEW BY THIS OFFICE PRIOR TO PERFORMING THIS WORK.
- GS MATERIALS AND WORKMANSHIP SHALL BE IN ACCORDANCE WITH THE FOLLOWING:
 - THE SPECIFICATION,
 - THE CURRENT REVISION OF ALL RELEVANT SAA CODES,
 - THE REQUIREMENTS OF THE VICTORIA BUILDING REGULATIONS
 - THE BUILDING CODE OF AUSTRALIA,
 - LOCAL AUTHORITIES AND THE PROVISIONS OF THE CURRENT HEALTH AND OCCUPATIONAL HEALTH AND SAFETY ACT.
- G6 UNLESS NOTED OTHERWISE ON A PARTICULAR DRAWING THESE NOTES SHALL APPLY.
- G7 THE FOLLOWING DESIGN LIVE LOADS HAVE BEEN ADOPTED FOR THIS PROJECT: CHIMNEY BASE 5.0 kPa. ROOF (1.8/A + 0.12) or 0.25 kPa.
- G8 WIND LOADING IMPORTANCE LEVEL -TERRAIN CATEGORY -ANNUAL PROBABILITY OF EXCEEDENCE: STRENGTH LIMIT STATE DESIGN - 1 in 1000 SITE GUST WIND SPEEDS: STRENGTH LIMIT STATE DESIGN -44.2m/s for 0 to 10m
- G9 EARTHQUAKE LOADING ANNUAL PROBABILITY OF EXCEEDENCE: STRENGTH LIMIT STATE DESIGN - 1 in 1000 EARTHQUAKE DESIGN CATEGORY - II
- G10 CONTRACTORS SHALL ENSURE THAT LOCATIONS OF ALL UNDERGROUND SERVICES ARE IDENTIFIED PRIOR TO COMMENCEMENT OF WORKS AND EXCAVATIONS.
- G11 SITE DRAINAGE SHALL BE MANAGED BY THE BUILDER DURING CONSTRUCTION TO PREVENT EROSION OF BATTERS AND PONDING OF WATER AROUND AND AGAINST FOOTINGS

CONTRACTOR TO ORGANISE INSPECIONS BY OUR OFFICE OF PROGRESS WORKS PARTICULARLY BRICKWORK REMEDIATION & SHAFT REBUILD -

BRICKWORK

GENERAL

ALL REPAIRS TO EXISTING BRICKWORK TO BE IN ACCORDANCE WITH AS3700 UNLESS OTHERWISE SPECIFIED. ONLY BRICKLAYERS WITH DEMONSTRATED COMPETENCY IN THE RESTORATION AND REPAIR OF HISTORIC BRICKWORK SHALL BE EMPLOYED ON THE PROJECT. THE AIM OF THE REPLACEMENT/REPAIR WORK INVOLVES THE MINIMAL INTERVENTION AND REPLACEMENT, AND MAXIMUM RETENTION OF ORIGINAL.

ALL NEW BRICKS TO BE SECOND HAND SOLID BRICKS FOM SIMILAR AGED CONSTRUCTION. ANY NEW BRICKS PERMITTED ARE TO BE TESTED FOR SALT CONTENT AND MAY BE REJECTED ON THIS BASIS DEPENDING ON SALT CONTENT. TESTING TO BE CARRIED OUT BY SHARP & HOWELLS P/L 9850 9722. CONTRACTOR TO ALLOW IN PRICING FOR COSTS OF TESTING IF BRICKS TO BE IMPORTED.

MORTAR FOR REPOINTING & FOR REBUILT BRICKWORK TO BE "COURSE STUFF" PREMIXED LIME SAND MORTAR AVAILABLE FROM WESTOX (BARRIE COOPER 02 9774 4100 OR www.westox.com), WHICH IS MADE FROM THE FOLLOWING INGREDIENTS:

PART A - 1 LIME PUTTY (MATURED APPROX 1 MONTH) TO 3 SAND (TRIPLE WASHED SYDNEY COARSE SAND TO OBTAIN GOOD PERMEABILITY).

PART B - SLAG CEMENT OR META KAOLIN (POZZOLANIC ADDITIVE - APPROX. 1/20 BY VOLUME TO LIME).

EXECUTION

ALL BRICKWORK REPAIRS TO BE CARRIED OUT IN ACCORDANCE WITH RECOGNISED TRADE BEST PRACTICE. SAMPLE OF NEW BRICKWORK AND REPAIR BRICKWORK TO BE

PREPARED FOR APPROVAL BY CLIENT AND SUPERINTENDENT. EVIDENCE OF MORTAR MIX TO BE PROVIDED. CONTRACTOR TO ALLOW FOR COST OF TESTING BY BMRL TO CONFIRM MIX USED IF REQUIRED.

PART A & PART B TO BE MIXED THE DAY BEFORE USE & LEFT OVERNIGHT. NOTE MIXING TO BE DONE IN PRESCRIBED QUANTITIES AND IS TO BE DONE TO ENSURE THOROUGH COMPRESSION AND BEATING. ROTARY DRUM MIXERS ARE NOT RECOMMENDED AS THEY CANNOT PROVIDE COMPRESSION. MIX THEN TO BE KNOCKED UP PRIOR TO USE ON DAY OF USE. THE CONTRACTOR SHALL NOT DEVIATE FROM THE APPROVED MATERIALS AND METHODS SPECIFIED IN THIS SPECIFICATION, EXCEPT WITH THE EXPRESS APPROVAL OF THE SUPERINTENDENT.

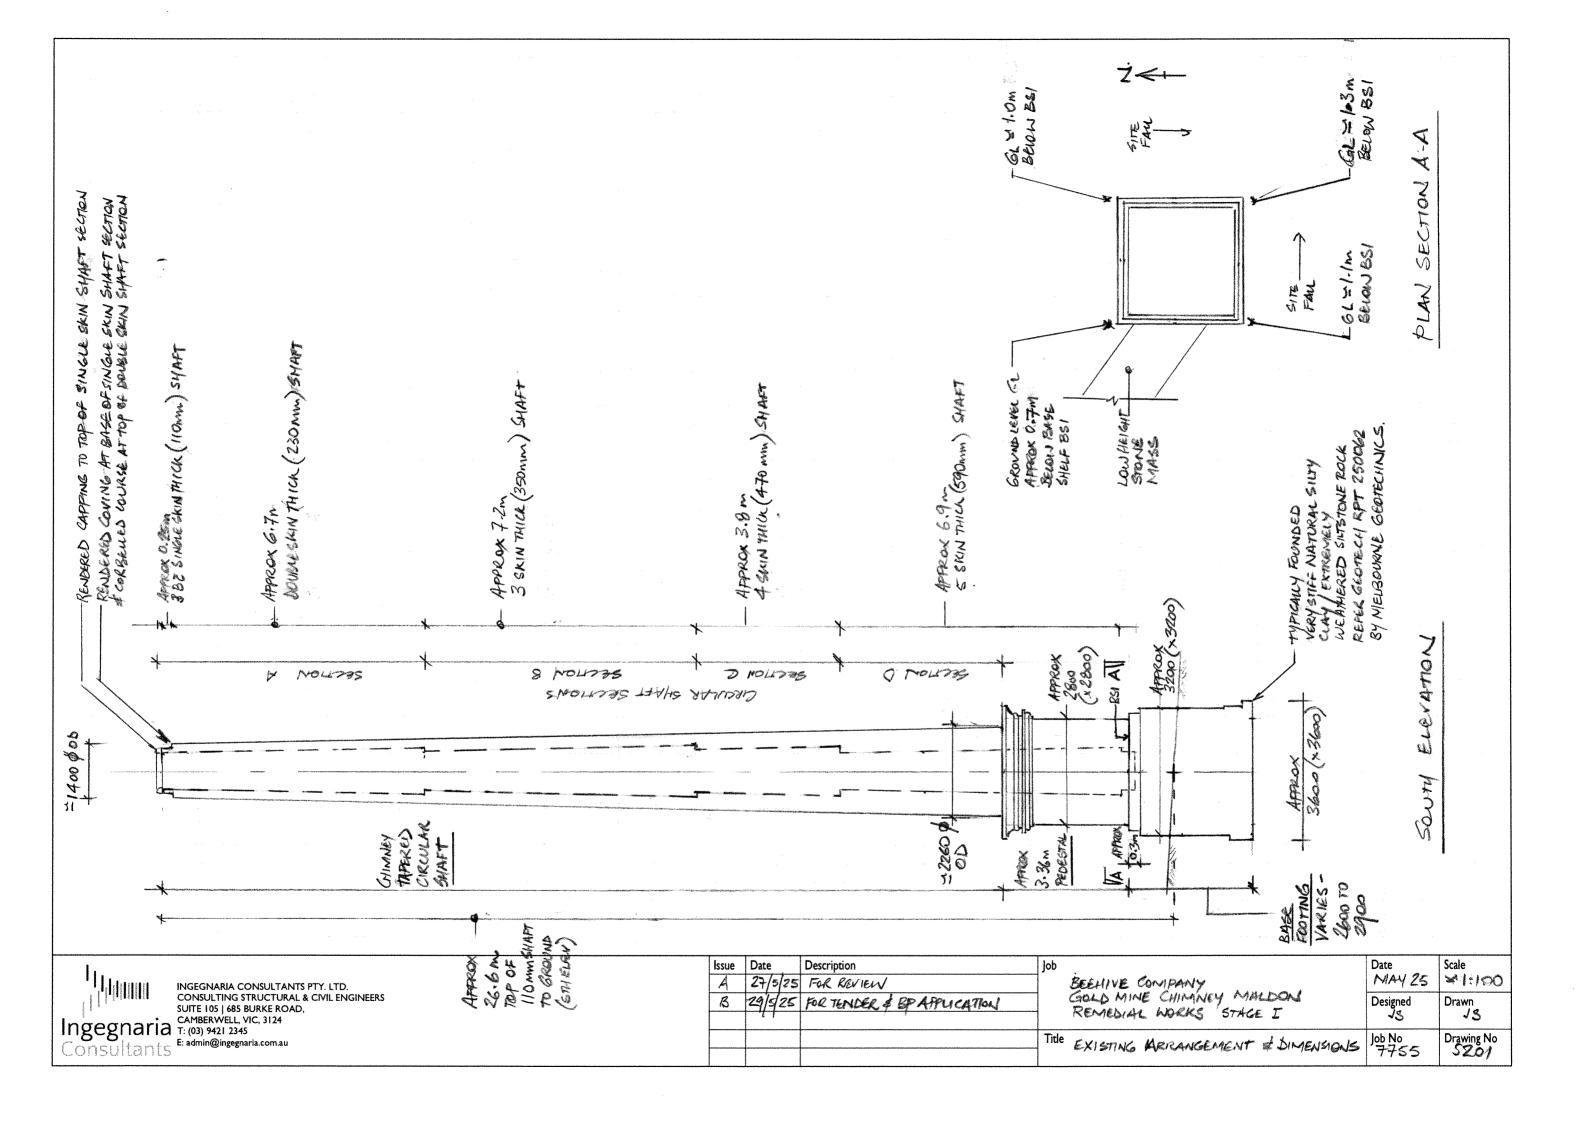
IMPORTANT NOTES FOR MORTAR, RENDER & PLASTER MIXES.

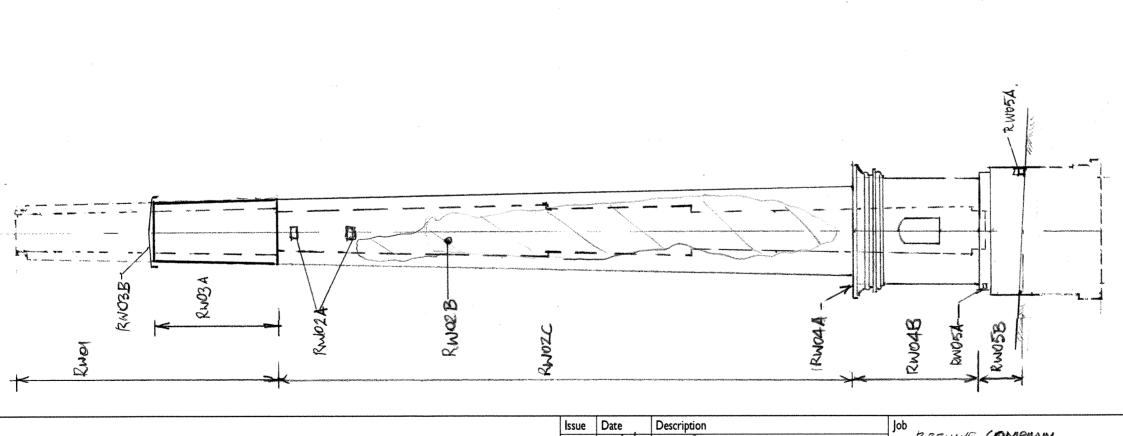
- NORMAL PORTLAND CEMENT OR ADMIXTURES ARE NOT TO BE USED IN ANY OF THE MIXES UNDER ANY CIRCUMSTANCES.
- ALL MIX RATIOS BY VOLUME AND TO BE MEASURED WITH A MEASURING DEVICE (eg., VOLUME MARKED BUCKET NOT SHOVELS).
- CAUTION TO BE USED IN WORKING WITH LIME PUTTY (SLAKED LIME) - OPERATORS SHOULD USE GOGGLES & PROTECTIVE CLOTHING INCLUDING GLOVES.
- LOCAL SAND TO BE TRIPLE WASHED WITH FRESH WATER ON EACH WASHING.
- WATER TO BE CLEAN FRESH DRINKING WATER FREE OF ANY IMPURITIES THAT WOULD REACT WITH THE LIME & THE MIX PROPORTIONS.
- ANY DAMP OR SALTS FOUND IN THE WALL TO BE INVESTIGATED AND TESTED PRIOR TO APPLICATION OF LIME: SAND MORTAR, RENDER & PLASTERS.

Issue	Date	Description	Job	Date	Scale
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B	29/5/25	FOR YOURE & BP AFFLICATION	GOLD MINE CHIMNEY MALDON	Designed	Drawn
	6 5		REMEDIAL WORKS STAGE I	JS	75
			Title Carta CA	Job No	Drawing No
			GENERAL NOTES	++55	5101



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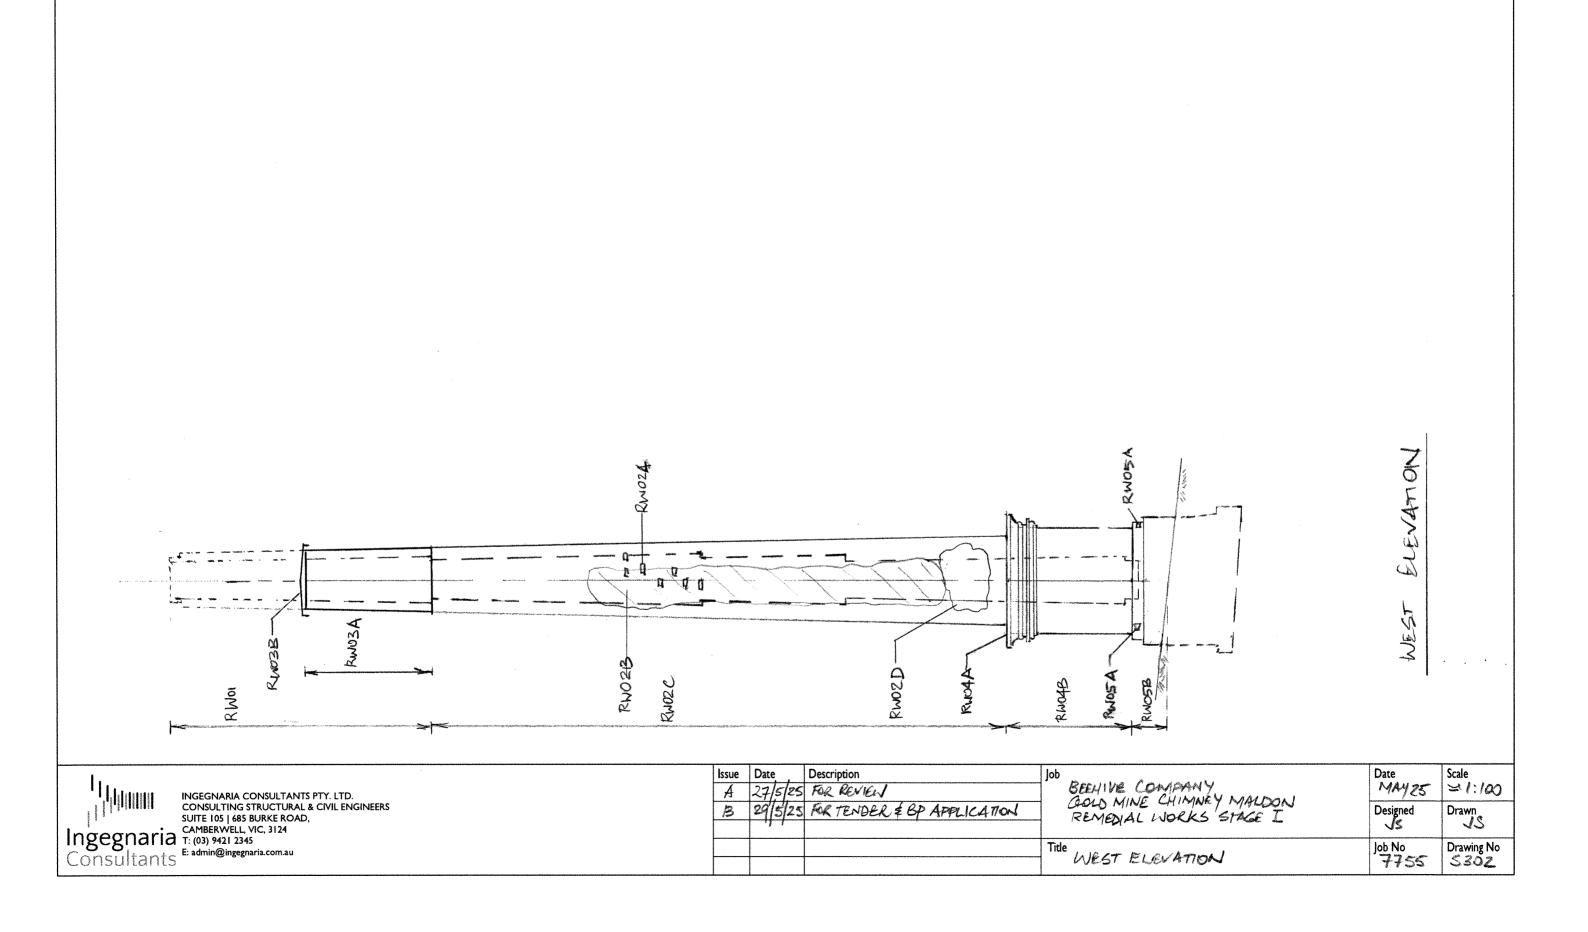


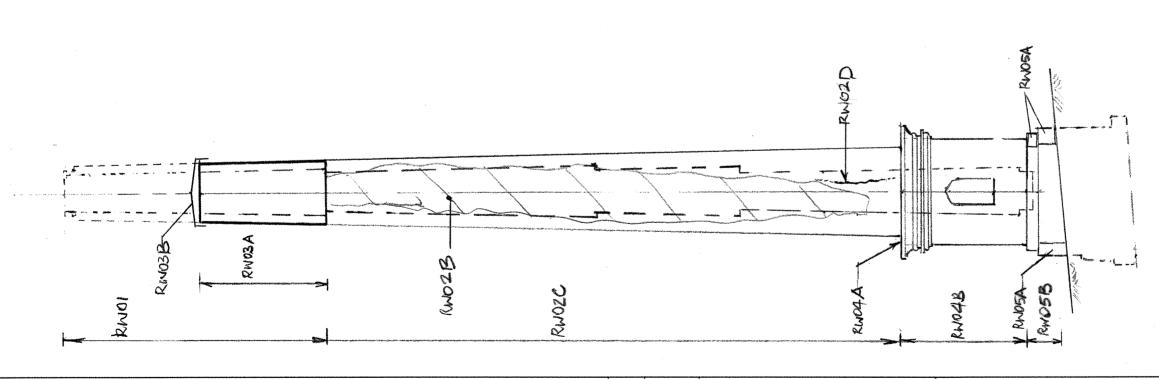
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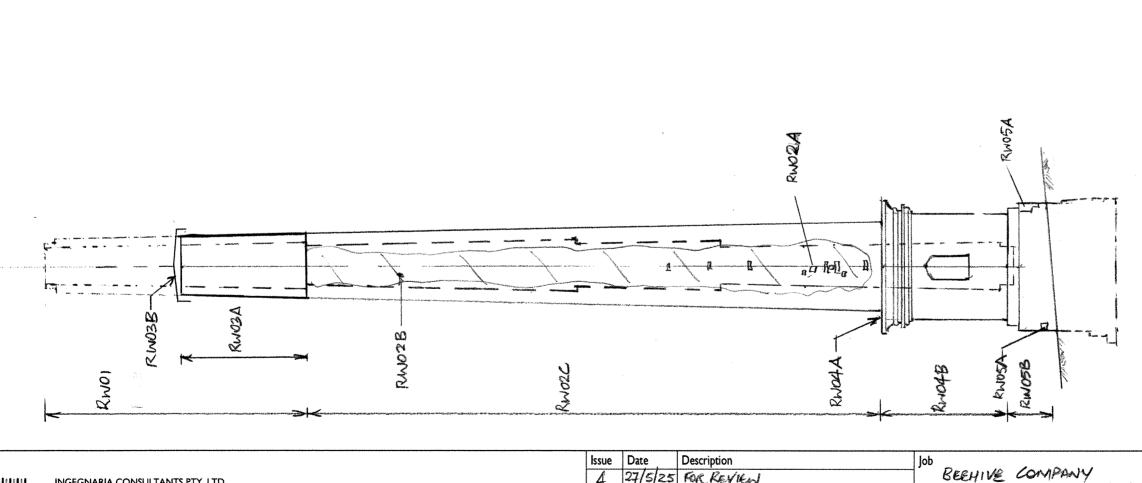
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BEENIVE COMPANY GOLD MINE CHIMNEY MALDON	Date MAY 25	
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GOLD MINE CHIMNEY MALDON RENEDIAL WORKS STAGE [Designed JS	Drawn JS
FEAST ELEVATION	Job No 7735	Drawing No S304

REMEDIA WORKS SCHEDULE

TYPE DESCRIPTION

DETAIL.

RWOI DENIOLISH TOP APPROX 7 METRES OF CHIMNEY SHAFT DOWN TO STEP CHANGE IN SHAFT WALL THICKNESS 230 TO 350 MM SALVACE & CLEAN BUCKS FOR REUSE.

RNOZ A FILLIN HOLES IN BRICKWORK

- B INVESTIGATE TEST GREY COLORED PREVIOUS REPAIR MORTAR
 IF CEMENT RICH-REMOVE & REPOINT.
 DEPTY OF PREVIOUS REPAIR MORTAR APPEARS TO BE APPROX 10 TO ZOMM
- C REPOINT BRICKHORK TO SHAFT'S RETAINED BRICKHORK
- D CRACK STITCH VERTICAL CRACKING

RESER DETAIL SUB2

- RWO3 A REBUILD APPROX 3.5 METRES OF CHIMNEY SHAFT

 TO 23 METRES MAX ABOVE GROUND LEVEL MEASURED ON
 SOUTH ELEVATION, IN 230 MM BRICKWORK BOND PATTERN
 TO MATCH EXISTING CHIMNEY SHAFT BRICKHOOK.
 - B. PROVIDE METAL CAPPING TO WHOLE OF SHAFT. NOTE CAPPING TO BE TIED DOWN TO NEW BRICKWORK.

REFER DETAIL SCHOOL

- RWOL A CLEAN & PREPARE TOP SURFACE OF UPPER CORNICE TO PEDESTAL & PROVIDE WEATHERSTRUCK RENDER COATING FROM SHAFT TO EDGE OF CORNICE
 - B INVESTIGATE PEDESTAL'S RENDER COATING COMPOSITION FLAYERS & MIX) TO INFORM RENDER REPAIR TOP COAT
- RWOS A FILL IN HOLES IN THE BASE'S BRICKWORK & STONEWORK
 - B REPAIR ALL MORTAR BETWEEN THE BASE'S BRICKS

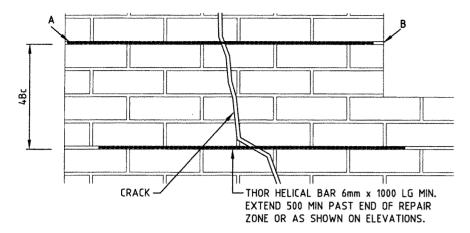
NOTES

- 1. REPOINTING MORTAR TO BE 1:3 LIME: BAND MORTAR
 REFER EXISTING MORTAR COMPASSION TEST RPT Nº 25-0208
 BY SHARP & HOWELLS 26/5/25
- 2. FOR REPOINTING TENDERERS TO PROVIDE SEPARATE PRICING AS FOLLOWS:
 - MAXIMUM WORK WHICH INCLUDES REMOVAL OF AU PREVIOUS MORTAN REPOINTING AND PREPARATION OF ENTIRE RETAINED SHAFT SECTIONS B, C&D (REFER SZOI) FOR FULL REPOINTING OF BRICKWORK. TOTAL SURFACE AREA FOR SECTIONS B,C,D = 100 SQ, METRES
 - MINIMUM WORK WHICH INCLUDES RETENTION OF ALL PREVIOUS MORTAR REPOINTING AND PREPARATION OF AREAS TO RETAINED SHAFT GETTONS B, C, & D REQUIRING REPOINTING MORTAR REPAIRS ONLY. TOTAL EST. SURFACE AREA = 33 SQ. METRES
- 3. TENDERERS TO ALLOW PROMISIONAL SUM OF \$5000 +6ST FOR ANY MORTAR & RENDER COMPOSITION TESTING.
- 4. FOR CRACK STITCHING, TENDERERS TO AMON FOR 10 METRES (10 Nº * 1 METRELONG) STAINLESS STEEL TWISTED HELIFIX BARS.

11.	
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CONSUITATIES	

Issue	Date	. ,	Description	Jol
A	27	5/25	FOR REVIEW	
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BERHIVE COMPANY	Date MAY 25	Scale
GOLD MINE CHIMNEY MALDONI REMEDIAL WORKS STACE I	Designed JS	Drawn JS
le REMEDIAL WORKS SCHEDULE	Job No 7755	Drawing No S401

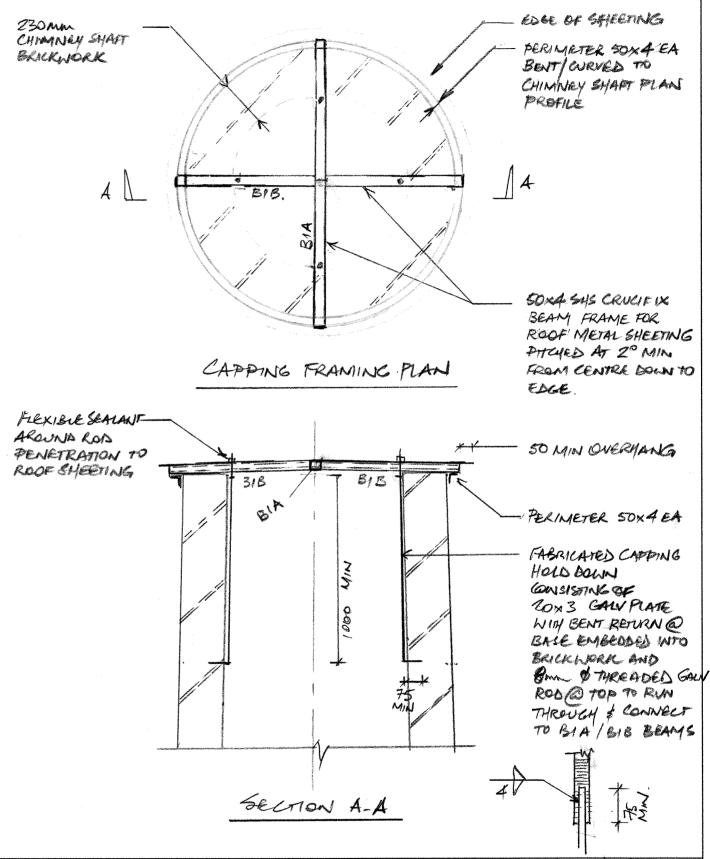


INSTALLATION PROCEDURE

- (1) RAKE OUT OR CUT SLOTS INTO HORIZONTAL MORTAR JOINT TO SPECIFIED DEPTH AND AT REQUIRED VERTICAL SPACING.
- (2) VACUUM OUT THE SLOTS AND THOROUGHLY FLUSH WITH WATER.
- (3) USING A FLATTENED GROUT NOZZLE INSERT A BEAD OF 'D4' CEMENTITIOUS GROUT INTO THE BACK OF THE SLOT.
- (4) PUSH THE THOR HELICAL (GRADE 304 STAINLESS STEEL) ROD INTO THE GROUT TO OBTAIN GOOD COVERAGE.
- (5) INSERT ANOTHER BEAD OF CEMENTITIOUS GROUT OVER THE EXPOSED ROD & IRON INTO THE SLOT USING THE FINGER TROWEL TO PROVIDE A REBATED FINISH.
- (6) IMMEDIATELY POINT UP OR FILL THE JOINT WITH 1:2:9 MORTAR MIX OR AS SPECIFIED.
- (7) REFER ALSO TO THOR HELICAL SPECIFICATION FOR CRACK STITCHING REPAIRS.

- UNLESS SPECIFIED OTHERWISE THE FOLLOWING CRITERIA ARE
- (a) DEPTH OF SLOT TO BE 30mm FOR SINGLE SKIN BRICKWORK & 45mm FOR 230mm BRICKWORK.
- (b) INSTALL TIES UNDER HEADER COURSES IF POSSIBLE.
- (c) HELICAL ROD IS TO EXTEND A MINIMUM OF 500mm EACH SIDE OF CRACK.
- (d) NORMAL VERTICAL SPACING IS 345mm (4 BRICK COURSES) U.N.O.
- (e) WHERE A CRACK IS WITHIN 500mm OF THE END OF WALL (AS PER 'A' ABOVE) THE HELICAL ROD IS TO CONTINUE FOR AT LEAST 100mm AROUND THE CORNER & FIXED INTO THE ADJOINING WALL.
- (f) WHERE A CRACK IS WITHIN 500mm OF AN OPENING (AS PER 'B' ABOVE) THE HELICAL ROD IS TO BE BENT BACK AND FIXED INTO THE REVEAL.

CRACK STITCHING - GENERAL





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Issue	Date	Description	Job
A		Noi (ssuei)	7 2
B	29/5/25	FORTENDER & BP APPLICATION	
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BERHIVE COMPANY GOLD MINE CHIMNEY NIALDON REMEDIAL WORKS STAGE I	Date May 25	Scale AS NOTED
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DETAILS & SECTIONS	Job No 7755	Drawing No