
APPENDIX B: CONSERVATION DRAWINGS

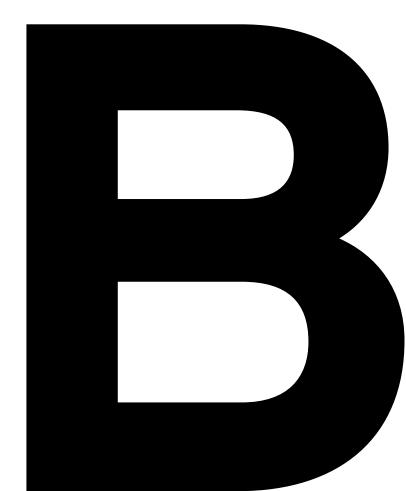

ROBUR TEA BUILDING CONSERVATION WORKS

28 CLARENDON STREET, SOUTHBANK, VICTORIA 3006

DRAWING LIST

COVER PAGE AND CONSERVATION METHODS OF REPAIR

EXTERNAL CONSERVATION WORKS - EAST ELEVATION

EXTERNAL CONSERVATION WORKS - SOUTH ELEVATION

EXTERNAL CONSERVATION WORKS - WEST ELEVATION EXTERNAL CONSERVATION WORKS - NORTH ELEVATION

INTERNAL CONSERVATION WORKS

CONSERVATION WOKRS

ALL DRAWINGS ARE TO BE READ IN CONJUNCTION WITH DESIGN ARCHITECTS AND ALL CONSULTANTS DOCUMENTATION.

ALL WORK TO COMPLY WITH RELEVANT AUSTRALIAN STANDARDS

EXTERNAL CONSERVATION WORKS NOTES:

UNDERTAKE FAÇADE CLEANING TO ALL ELEMENTS TO REMOVE ORGANIC GROWTH, LICHEN, MOSS, VEGETATION AND DEBRIS WITH LOW PRESSURE WARM WATER AND DISINFECTANT

REMOVAE ALL REDUNDANT SERVICES, FIXTURE AND FITTINGS INCLUDING BRACKETS, LIGHTING, LIGHTING CABLES, MOUNTING, BOLTS, NAILS, PIPES, CONDUITS, SEALANTS, TIMBER AND THE LIKE PRIOR TO UNDERTAKING

ENSURE EMBEDDED METAL ITEMS ARE REMOVED FROM THE SUBSTRATE IN

WHERE NEW OPENINGS ARE NOMINATED BRICKWORK AND BLUESTONE SILLS TO BE CAREFULLY DISMANTLED AND SET ASIDE FOR REBUILDING

UNDERTAKE REPAIRS TO BRICKWORK WHERE NOMINATED USING SALVAGED BRICKS INCLUDING REPLACEMENT OF DAMAGED / CRACKED BRICKS AND REPOINTING IN ACCORDANCE WITH THE METHOD OF REPAIR ALL REPOINTING TO THE EAST / CLARENDON STREET ELEVATION TO BE TUCK

UNDERTAKE REPAIRS TO CRACKED, DETACHING AND DEFECTIVE RENDER TO

PLAIN / FLAT SURFACES, MOULDED RENDER, COPINGS, CORNICES AND THE LIKE IN ACCORDANCE WITH THE METHOD OF REPAIR UNDERTAKE REPAIRS TO STONEWORK WHERE NOMINATED CONSISTING OF CRACK INJECTION AND INDENT REPAIRS IN ACCORDANCE WITH THE

METHOD OF REPAIR UNDERTAKE PAINT REMOVAL TO ALL LEVEL 5 STONE WINDOW LINTELS ALLOWING TO UNDERTAKE PAINT REMOVAL SAMPLES TO ENSURE NO DAMAGE OR STAINING TO STONE WORK OCCURS

FOLLOWING PAINT REMOVAL TO LEVEL 5 STONE WINDOW LINTLES HAND SCABBLE UNDERSIDE OF LINTEL TO REMOVE LOOSE AND DELAMINATING STONE, PRIOR TO WORKS STONE TO BE INSPECTED BY HERITAGE ARCHITECT

REMOVE EXISTING FORMED METAL TEA HOUSE SIGN TO THE NORTH AND

SOUTH ELEVATIONS, INCLUDING ALL EMBEDDED FIXINGS AND UNDERTAKE

RENDER REPAIRS TO FIXING LOCATIONS PREPARE AND PAINT EXISTING SIGNS TO BOTH SIDES OF THE BUILDING INCLUDING REINSTATING OF "THE TEA HOUSE" LETTERING


REMOVE AND UNDERTAKE REPAIRS TO ALL CAST IRON EAVES GUTTETS, RAINWATER HEADS AND ASSOCIATED BRACKETS AND FIXING AND **REINSTATE TO ORIGINAL LOCATIONS**

REPLACE ALL EXISTING DOWNPIPES WITH GALVANISED STEEL TO MATCH EXISTING SIZE AND PROFILE REPLACE ALL EXISTING FLASHING, PARAPET CAPPING, RIDGE CAPPING, BOX

GUTTERS AND THE LIKE, IN GALVANISED STEEL TO MATCH EXISTING.

ALL PREPARATION OF RETAINED METAL WORK TO INCLUDE REMOVAL OF RUST AND FLAKING MATERIAL USING A NONFERROUS STIFF BRISTLE BRUSH AND SPOT PRIMED PRIOR TO PRIMING AND PAINTING WORKS.

GENERALLY PREPARE AND RE-PAINTING OF ALL PREVIOUSLY PAINTED

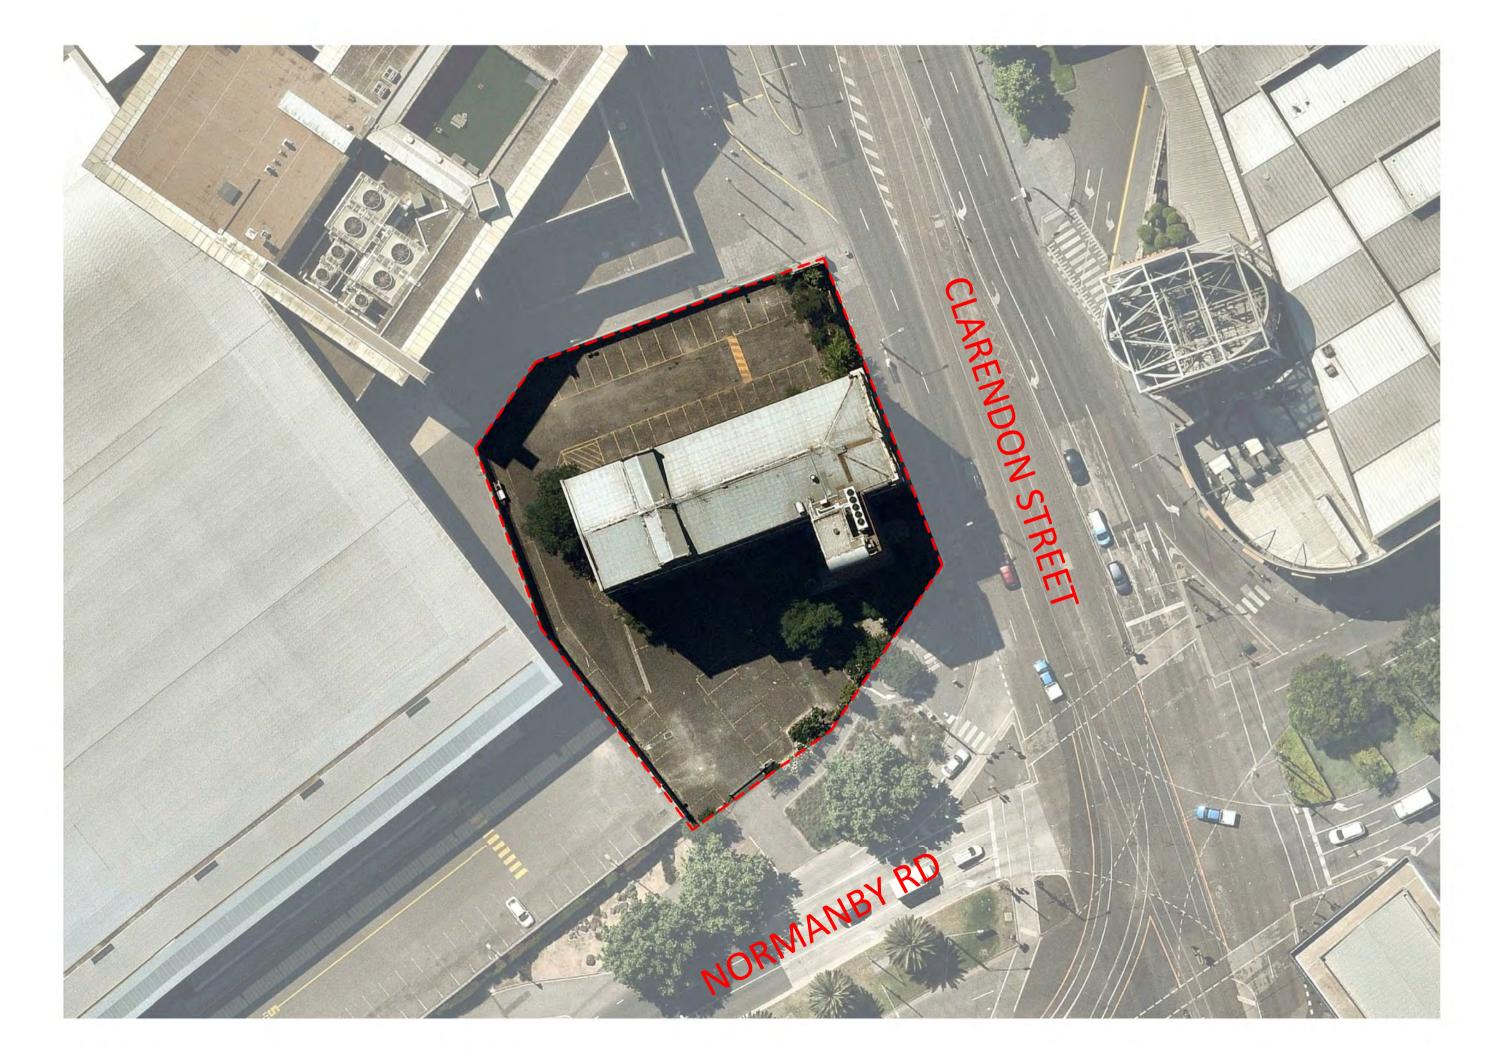

METHODS OF REPAIRS: GENERAL REPAIRS:

REMOVE ALL ORGANIC GROWTH, GUANO, DIRT, MORTAR AND CEMENT RESIDUE, CALCIMINE FINISHES, INDUSTRIAL CARBON RESIDUES AND THE LIKE TO ALL MASONRY AND RENDERED/ CONCRETE SURFACES.

CLEANING OF EXISTING SURFACES IS TO BE UNDERTAKEN PRIOR TO COMMENCEMENT OF ALL OTHER WORKS. CLEANING IS TO BE UNDERTAKEN BY APPROVED SUB-CONTRACTOR EXPERIENCED IN THE FAÇADE CLEANING. DO NOT CAUSE DAMAGE TO EXISTING MATERIAL OR STRUCTURE. TREAT ORGANIC GROWTH TO BRICKWORK AND RENDERED AREAS WITH PEERLESS

JAL QUATRAMINE 50 (OR EQUIVALENT) IN DILUTED SOLUTION OF 1:10 AND WASH DOWN FACADES WITH LOW PRESSURE WATER FROM 300PSI TO 600PSI MAX. AT 60°C TO 90°C MAX SCRUBBING WITH A NYLON BRUSH TO REMOVE DEBRIS. UNDERTAKE SPOT TEST WITH PH STRIPS TO CONFIRM THE SUBSTRATE IS

CAPTURE ALL WASTE AND WATER RUNOFF FOR DISPOSAL IN ACCORDANCE WITH RELEVANT AUTHORITIES' GUIDELINES.

REMOVE REDUNDANT FIXTURES AND FITTINGS

DEMOLISH AND REMOVE REDUNDANT SERVICES, FIXTURES AND FITTINGS FROM FACADES, INCLUDING BRACKETS, LIGHTING, LIGHTING CABLES, MOUNTING PLATES, BOLTS, NAILS, PIPES, CONDUITS, SEALANTS AND THE LIKE. UNDERKE REPAIRS TO THE RENDER AND MASONRY SUBSTRATE FOLLOWING REMOVAL. WHERE HOLES ARE LARGER THAN 30MM DIAMETER CUT OUT AND REPLACE THE BRICK AND RE-RENDER (IF PREVIOUS SURFACE IS RENDERED) WHERE HOLES ARE LESS THAN 30MM, PATCH REPAIR WITH MORTAR, AND RE-RENDER (IF PREVIOUS SURFACE IS RENDERED). PATCH REPAIR HOLES WITH COLOUR MATCHED MORTAR CONTAINING ABILOX COLOUR PIGMENT TO MATCH SUBSTRATE / FINISH COLOUR.

REMOVE EMBEDDED METAL / TIMBER / PLASTIC

REMOVE EMBEDDED METAL / TIMBER / PLASTIC ITEM, WHERE REQUIRED CUT OUT SURROUNDING RENDER OR BRICKWORK TO ALLOW EMBEDDED METAL ITEMS TO BE REMOVED AND CLEAN WITH COMPRESSED AIR OR WATER. WHERE HOLES ARE TO RENDER, PATCH REPAIR RENDER TO MATCH ORIGINAL. WHERE MOULDED UNDERTAKE REPAIR IN ACCORDANCE WITH RENDER REPAUR TO

WHERE REMOVAL IS FROM BRICKWORK, REPAIR HOLE LESS THAN 30MM DIAMETER BY PATCH REPAIRING THE BRICK WITH COLOURED MORTAR CONTAINING ABILOX COLOUR PIGMENT TO MATCH BRICK COLOUR. PRIOR TO COMMENCING THE WORKS UNDERTAKE IN SITU SAMPLES OF MORTAR REPAIR TO COLOUR MATCH THE BRICK TO THE SATISFACTION OF THE HERITAGE ARCHITECT. WHERE HOLE IS GREATER THAN 30MM DIAMETER, CUT OUT THE EXISTING BRICK AND INSTALL A NEW SALVAGED BRICK TO MATCH THE EXISTING ENSURING THE BOND IS

POULTICE SALT EFFLORESCENCE

INSITU MOULDING METHODOLOGY.

ELIMINATE THE CAUSE OF EFFLORESCENCE PRIOR TO COMMENCEMENT OFF ANY SALT TREATMENT (E.G. REPAIR LEAKS). REMOVE ANY LOOSE SURFACE SALTS FROM BRICKWORK WITH A STIFF BRISTLE NON-FERROUS BRUSH TO PROVIDE A REASONABLY SOUND SURFACE. CAPTURE SALTS AND UNDERTAKE TESTING TO DETERMINE TYPE AND CONFIRM TREATMENT METHOD, DISPOSE OF ALL SALTS OFF

ALLOW FOR TREATMENT USING WESTOX COCOON IN ACCORDANCE WITH MANUFACTURER'S SPECIFICATION AND GUIDELINES, ALLOW FOR TWO APPLICATIONS TO EACH LOCATION AND 28 DAYS BEFORE REMOVAL OF EACH **APPLICATION**

PIGMENTED MORTAR MIX REPAIR

UNDERTAKE MORTAR REPAIR SAMPLES IN-SITU TO MATCH ADJACENT COLOUR, TEXTURE AND PHYSICAL CHARACTERISTIC TO THE SATISFACTION OF THE HERITAGE ARCHITECT. THE AGREED SAMPLE SHALL BE THE METHOD FOR WHICH MORTAR REPAIR WORKS SHALL BE UNDERTAKEN AND ASSESSED. PREPARE SAMPLES WITH COLOUR TO MATCH EACH MATERIAL FOR APPROVAL. MORTAR COLOUR IS ASSUMED TO BE ACHIEVED FROM SANDS AND ADDITIONAL NATURAL ABILOX PIGMENT IF REQUIRED. ENSURE MORTAR COLOUR MATCHES ADJACENT MATERIAL. CARRY OUT MORTAR REPAIR TO AREAS OF MASONRY WORK ENSURING ARISES AND MOULDINGS ARE RESTORED. WHERE REQUIRED, BUILD UP AN ARMATURE OF STAINLESS STEEL SCREWS AND WIRE INTO SUBSTRATE. APPLY MORTAR MIX TO THE ARMATURE FORMING REQUIRED PROFILES.

PAINT REMOVAL FROM RENDER, MASONRY, CONCRETE AND TIMBER

REMOVE ALL EXISTING PAINT FROM RENDER, CONCRETE, MASONRY OR TIMBER FINISHES USING CHEMICAL PAINT STRIPPER PEEL AWAY HEAVY DUTY AND LOW PRESSURE WATER IN ACCORDANCE WITH THE MANUFACTURER'S SPECIFICATIONS. PROVIDE PROTECTION TO ALL WINDOWS AND DOORS AND ENCAPSULATION TO SCAFFOLD.

ALL PAINT REMOVAL AND DISPOSAL ARE TO BE UNDERTAKEN IN ACCORDANCE WITH AS 4361.1 AND AS 4361.2 GUIDE TO HAZARDOUS PAINT MANAGEMENT. UNDERTAKE SAMPLES OF PAINT REMOVAL IN-SITU TO THE SATISFACTION OF THE HERITAGE ARCHITECT TO DETERMINE THE APPROVED METHOD OF PAINT REMOVAL. THE AGREED SAMPLE SHALL BE THE METHOD FOR WHICH PAINT REMOVAL WORKS SHALL BE UNDERTAKEN AND ASSESSED.

ALL PAINT REMOVAL WORKS ARE TO BE UNDERTAKEN BY A SUITABLY QUALIFIED CONTRACTOR WITH EXPERIENCE IN PAINT REMOVAL AND PRESSURE CLEANING HERITAGE LISTED BUILDINGS. DO NOT CAUSE DAMAGE TO EXISTING MATERIAL OR STRUCTURE. ALLOW FOR REPOINTING TO BRICKWORK AREAS.

BRICKWORK REPAIRS:

RACK OUT EXISTING DEGRADED MORTAR TO A MIN. DEPTH OF 20MM USING AN ARBORTECH MORTAR SAW, DO NOT USE GRINDERS OR OTHER CUTTING TOOLS THAT MAY DAMAGE THE EXISTING BRICKS.

REPOINT THE EXISTING JOINTS WITH MORTAR TO MATCH THE EXISTING ADJACENT WEATHERED FINISH. ALL JOINTS ARE TO BE RECESSED 2MM BACK FROM THE FACE OF THE BRICK AND TO BE BRUSHED BACK TO EXPOSE THE AGGREGATE AND GIVE A WEATHERED FINISH. DO NOT FILL MISSING ARRISES OR COMPONENTS OF THE

REPOINT BRICKWORK – TUCK POINTING

RACK OUT EXISTING DEGRADED MORTAR TO A MIN. DEPTH OF 20MM USING AN ARBORTECH MORTAR SAW. DO NOT USE GRINDERS OR OTHER CUTTING TOOLS THAT MAY DAMAGE THE EXISTING BRICKS.

REPOINT THE EXISTING JOINTS WITH RED STOPPING MORTAR, ALLOW TO INCORPORATE BRICK DUST AND NATURAL MINERAL PIGMENT INTO THE MORTAR TO MATCH EXISTING MORTAR COLOUR. PROVIDE SAMPLES OF COLOUR MATCHED MORTAR TO THE APPROVAL OF THE HERITAGE ARCHITECT. ALL JOINTS ARE TO BE FINISHED TO MATCH EXISTING ADJACENT FLUSH JOINT. DO NOT FILL THE FACE OF

WHEN THE STOPPING MORTAR IS FIRM BUT HAS NOT FULLY SET. APPLY THE TUCKING MORTAR TO CORRESPOND BED AND PERPEND JOINTS AT REGULAR INTERVALS, PERPEND JOINT MUST ALIGN VERTICALLY, DO NOT APPLY THE NEW TUCKING MORTAR ON REMAINDERS OF THE OLD STOPPING MORTAR. ALL NEW TUCK POINTING TO BE APPLIED ON NEW STOPPING MORTAR. TUCKING MORTAR TO CONSIST OF LIME PUTTY AND VERY FINE SAND OR STONE DUST. COLOUR OF TUCKING MORTAR TO BE ACHIEVED USING ADDITIONAL NATURAL MINERAL PIGMENT TO MATCH THE COLOUR OF THE ORIGINAL TUCK POINTING (DARK GREY/BLACK). PROVIDE SAMPLES OF COLOUR MATCHED MORTAR TO THE APPROVAL OF THE HERITAGE ARCHITECT.

CRACK REPAIRS IN BRICKWORK

INSTALL NEW 316 STAINLESS STEEL *HELIBARS* INTO MORTAR JOINTS AND REPOINT ALL JOINTS TO MATCH ADJACENT FINISH.

DISMANTLE AND REBUILD MASONRY WALL

WHERE NOMINATED FOR DISMANTLING, DO NOT CUT BRICKS; ALL BRICKS ARE TO CAREFULLY BE DISMANTLED BY HAND, CLEANED, SORTED, PALLESTISED AND STORE ON SITE FOR REUSE. ALL FACE BRICKS ARE TO BE CHALKED ON THE OUTER FACE AND STACKED FACING THE SAME DIRECTION TO ENABLE ACCURATE REBUILDING OF WORKS. ALLOW FOR DISLODGING BY HAND THE BRICKS ADJACENT TO THE AREA WHERE BRICKWORK IS TO BE RECONSTRUCTED. WHERE BRICK INFILLS ARE NOMINATED FOR RECONSTRUCTION, REBUILD BONDED

BRICKWORK USING CLEAN SALVAGE BRICKS KEYED INTO EXISTING BRICKWORK AND REBUILDING EXISTING BOND, DETAILS AND PROFILE, PREPARE AND REPOINT AREA WHERE FORMING NEW OPENING IN BRICK MASONRY, CAREFULLY DISMANTLE EXISTING BRICKWORK TO FORM NEW OPENING INCORPORATING NEW LINTELS AND THE LIKE. REBUILD THE BOND WITH WHOLE BRICKS TO THE OPENING AND CLOSER BRICKS (QUARTER BRICKS) SET IN ONE BRICK FROM THE OPENING (WHETHER STRETCHER OR HEADER) WITH SALVAGED BRICKS, REBUILD SEGMENTAL ARCHES USING CLEAN SALVAGE VOUSSOIRS TO MATCH EXISTING PROFILE AND DETAIL. SUPPLY AND INSTALL LINTELS TO STRUCTURAL ENGINEER'S DETAIL. MAKE ALL REBATES REQUIRED TO INSTALL JOINERY, FRAMES AND THE LIKE. PREPARE AND

WHERE A SHORT FALL OF EXISTING BRICKS IS FOUND, SUPPLY SALVAGED BRICKS TO MATCH EXISTING. SAMPLE TO BE PROVIDED TO THE HERITAGE ARCHITECT FOR

BRICK MASONRY REPLACEMENT CUT OUT EXISTING DECAYED BRICK AND INSTALL SALVAGED BRICK TO LOCATION,

REBUILDING THE EXISTING BOND. REPOINT EXISTING JOINTS. WHERE A SHORT FALL OF EXISTING BRICKS IS FOUND, SUPPLY SALVAGED BRICKS TO MATCH EXISTING, SAMPLE TO BE PROVIDED TO THE HERITAGE ARCHITECT FOR

PAINTING REPAIRS:

PREPARE AND (RE)PAINT METALWORK

PREPARE AND PAINT ALL METAL WORK IN ACCORDANCE WITH THE SPECIFICATION. REMOVE ALL LOOSE, RUSTED AND FLAKED PAINT FROM EXISTING METAL WITH A NON-FERROUS BRISTLE BRUSH AND SPOT PRIME WITH ZINC RICH PRIMER. ALL PREPARATION IS TO BE UNDERTAKEN IN ACCORDANCE WITH AS 4361.1 AND AS 4361.2 GUIDE TO HAZARDOUS PAINT MANAGEMENT.

APPLY MINIMUM OF ONE FULL PRIMER COAT AND TOW FINISHING COATS IN ACCORDANCE WITH THE PAINT MANUFACTURER'S SPECIFICATION.

PREPARE AND (RE)PAINT TIMBERWORK

PREPARE AND PAINT ALL TIMBERWORK IN ACCORDANCE WITH THE SPECIFICATION. REMOVE ALL LOOSE AND FLAKED PAINT, FILL AND PATCH ALL HOLES, DINTS AND THE LIKE, GRAIN FILL TIMBER, SAND AND PREPARE TO RECEIVE PAINT. ALL PREPARATION IS TO BE UNDERTAKEN IN ACCORDANCE WITH AS 4361.1 AND AS 4361.2 GUIDE TO HAZARDOUS PAINT MANAGEMENT. APPLY MINIMUM OF ONE FULL PRIMER COAT AND TOW FINISHING COATS IN

ACCORDANCE WITH THE PAINT MANUFACTURER'S SPECIFICATION.

PREPARE AND (RE) PAINT RENDER

PREPARE AND PAINT ALL RENDER IN ACCORDANCE WITH THE SPECIFICATION. CAREFULLY CLEAN DOWN WALLS FROM WATER MARKS AND WATER-BORNE DEBRIS USING A WEAK SUGAR-SOAP SOLUTION, CONTAIN WATER SO THAT OTHER AREAS ARE NOT AFFECTED. DO NOT OVER-WASH, AND DO NOT USE CHLORINE BASED BLEACH. WIPE OFF ALL RESIDUES AT COMPLETION OF CLEANING. PREPARE EXISTING PAINTED RENDER BY REMOVING ALL LOOSE AND FLAKED PAINT, FILL AND PATCH REPAIR, SAND BACK SUBSTRATE. ALL PREPARATION IS TO BE UNDERTAKEN IN ACCORDANCE WITH AS 4361.1 AND AS 4361.2 GUIDE TO HAZARDOUS PAINT MANAGEMENT. APPLY PAINT SYSTEM IN ACCORDANCE WITH THE MANUFACTURER'S

SPECIFICATION, DO NOT FEATHER PAINT EDGES.

STONEWORK REPAIRS:

RAKE OUT EXISTING DEGRADED MORTAR TO A MINIMUM DEPTH OF 20MM USING AN ARBOTECH SAW, DO NOT USE GRINDERS OR OTHER CUTTING TOOLS THAT MAY

DAMAGE THE EXISTING STONEWORK. REPOINT THE EXISTING JOINTS WITH LIME PUTTY MORTAR. ALL JOINTS ARE TO BE RECESSED 2MM BACK FROM THE FACE OF THE BLUESTONE AND TO BE BRUSHED BACK TO EXPOSE THE AGGREGATE AND GIVE A WEATHERED FINISH TO MATCH THE FXISTING ADJACENT.

TO MINIMISE CLEANING OF THE STONE, DO NOT SMEAR EXCESS MORTAR OVER THE FACE OF THE STONE. ENSURE WORKS ARE UNDERTAKEN WITH CARE NOT TO CAUSE DAMAGE OR ADDITIONAL CLEANING OF STONE.

CLEAN OUT CRACKS WITH A COMPRESSED AIR JET AND FILL WITH THE APPROPRIATE MATERIAL LISTED BELOW AS APPROVED BY THE HERITAGE

WHERE STONE IS DETACHED, INSTALL GRADE 316 STAINLESS STEEL DOWELS FOR REINFORCING WITH MIXTURE OF STONE DUST OR MINERAL PIGMENT WITH EPOXY RESIN - MEGAPOXY H (LIQUID BASED), PIGMENTED EPOXY RESIN TO FINISH AT

LEAST 5 MM BELOW OUTER SURFACE WHERE CRACKING HAS OCCURRED ON VERTICAL SURFACES OR THE UNDERSIDE OF HORIZONTAL SURFACES, DRILL AND INJECT FROM ABOVE. PROVIDING DAMMING TO THE FACE OF THE CRACK TO PREVENT THE RESIN LEACHING THROUGH ONTO THE FACE OF THE STONEWORK DO NOT DRILL HOLES INTO CRACK THE DAMMING IS TO BE MIXTURE OF STONE DUST OR MINERAL PIGMENT WITH EPOXY RESIN -MEGAPOXY 69 (GEL BASED) TO FORM A PASTE TO MATCH THE COLOUR AND TEXTURE OF THE EXISTING STONEWORK. INSTALL MASKING TO CRACK PRIOR TO DAMMING AND EPOXY INJECTION TO PROTECT THE BLOCK FROM ANY RESIN SPILLAGE OR SEEPAGE; BLOCKS SHOWING SUCH EVIDENCE SHALL BE REPLACED AT THE CONTRACTOR'S OWN EXPENSE AND TIME. PIGMENTED EPOXY RESIN TO FINISH AT LEAST 5 MM BELOW OUTER SURFACE.

FILL THE REST OF THE CRACK WITH AN APPROVED PIGMENTED MORTAR MIX TO MATCH ADJACENT COLOUR, FINISH AND TEXTURE OF ADJACENT MATERIAL

CARVE AND INSTALL NEW INDENTS IN SPECIFIED STONE. CARVE OR CUT INDENTS FROM NEW STONE AND INSTALL GRADE 316 STAINLESS STEEL DOWELS WITH EPOXY TO FIX NEW STONE INDENTS INTO POSITION. INDENTS TO BE CUT FLUSH AND TIGHT WITHOUT JOINTS. DO NOT FEATHER NEW WORK INTO EXISTING, UNDERTAKE ALL SWEETENING REQUIRED TO INSTALL INDENTS. ALL INDENT SIZES ARE TO BE CONFIRMED ON SITE FOLLOWING ACCESS VIA THE SCAFFOLD OR THE LIKE.

RENDER REPAIRS

RENDER REPAIR TO PLAIN/FLAT SURFACES

CUT OUT DRUMMY, CRACKED OR DEFECTIVE RENDER BACK TO SOUND SUBSTRATE. CLEAN WITH COMPRESSED AIR OR WATER. BUILD UP NEW RENDER IN TRADITIONAL 3 COAT CEMENT RENDER TO MATCH

ORIGINAL DEPTH AND FINISH. FNSURE FACH RENDER COAT IS GIVEN SUFFICIENT TIME TO CURE BEFORE APPLICATION OF THE NEXT COAT. ENSURE COATS KEY INTO

RENDER REPAIR TO IN-SITU MOULDING

CUT OUT DRUMMY CRACKED OR DEFECTIVE MOULDED RENDER BACK TO SOUND SUBSTRATE. CLEAN WITH COMPRESSED AIR OR WATER. REMOVE ALL SURFACE CORROSION FROM EMBEDDED STEEL CLIPS OR ARMATURES

WHERE PRESENT, USING A NON-FERROUS STIFF BRISTLE BRUSH, PRIME METAL WITH ZINC-RICH METAL PRIMER. SUPPLY AND EPOXY FIX NEW GRADE 316 STAINLESS STEEL MESH TO SUBSTRATE. APPLY NEW RENDER TO MATCH ORIGINAL AND RE-RUN MOULDING IN-SITU,

BUILDING UP EACH COAT TO MATCH ORIGINAL PROFILE, BUILD UP IN THREE OR MORE COATS. ENSURE EACH RENDER COAT IS GIVEN SUFFICIENT TIME TO CURE BEFORE APPLICATION OF THE NEXT COAT. ENSURE COATS KEY INTO COAT BELOW.

CUT OUT CRACKED RENDER BACK TO SOUND SUBSTRATE TO A MINIMUM WIDTH OF 30MM. CLEAN WITH COMPRESSED AIR OR WATER. FILL CRACK WITH NEW RENDER AND RE-RUN MOULDINGS IN SITU TO MATCH

RENDER COPING / PARGING

ORIGINAL PROFILE AND FINISH.

CUT OUT DRUMMY, CRACKED OR DEFECTIVE RENDER BACK TO SOUND SUBSTRATE OF CAPPINGS TO PARAPETS, CORNICES AND MOULDING LEDGES. CLEAN WITH COMPRESSED AIR OR WATER.


BUILD UP NEW RENDER IN TRADITIONAL 3 COAT CEMENT RENDER TO MATCH ORIGINAL DEPTH AND FINISH REINSTATING FALLS TO REMOVE RAINWATER. ENSURE COATS KEY INTO COAT BELOW. ENSURE EACH RENDER COAT IS GIVEN SUFFICIENT TIME TO CURE BEFORE APPLICATION OF THE NEXT COAT.

PRESSED CEMENT PIN REPAIR

DRILL HOLE ON A RECIPROCATING SETTING, INTO CAST ELEMENTS AND/OR INTO SUBSTRATE, MINIMUM OF 50 MM INTO THE SOUND SUBSTRATE. CLEAN OUT WITH COMPRESSED AIR. DO NOT DRILL INTO CRACK. SUPPLY AND INSTALL GRADE 316 STAINLESS STEEL THREADED PIN TO BE FIXED WITH EPOXY INTO HOLE. RECESS PIN APPROXIMATELY 6 MM BELOW THE FINISHED.

RENDER SURFACE, PLUG WITH MORTAR MIX TO GIVE CONTINUOUS APPEARANCE TO MATCH THE EXISTING PROFILE.

NOT FOR CONSTRUCTION

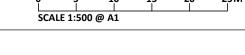

PRELIMINARY - FOR INFORMATION PRELIMINARY - FOR INFORMATION

1 AERIAL PHOTO

PRELIMINARY - FOR INFORMATION 01/05/2024 HERITAGE VICTORIA PERMIT APPLICATION NOTIFIED TO THE ARCHITECT.

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DESIGN ARCHITECT 178 Sturt Street Adelaide, SA 5000 STRUCTURAL ENGINEER ROBERT BIRD GROUP 4 Collins Square, Level 19/727 Collins St, Melbourne VIC 3000

COSTAFOX Suite 102, 54 Davis Avenue, South Yarra VIC 3141

LEVEL 5, 176 WELLINGTON PARADE EAST MELBOURNE 3002 AUSTRALIA TEL +61 (0)3 9667 0800 enquiry@lovelichen.com.ar www.lovelichen.com.au

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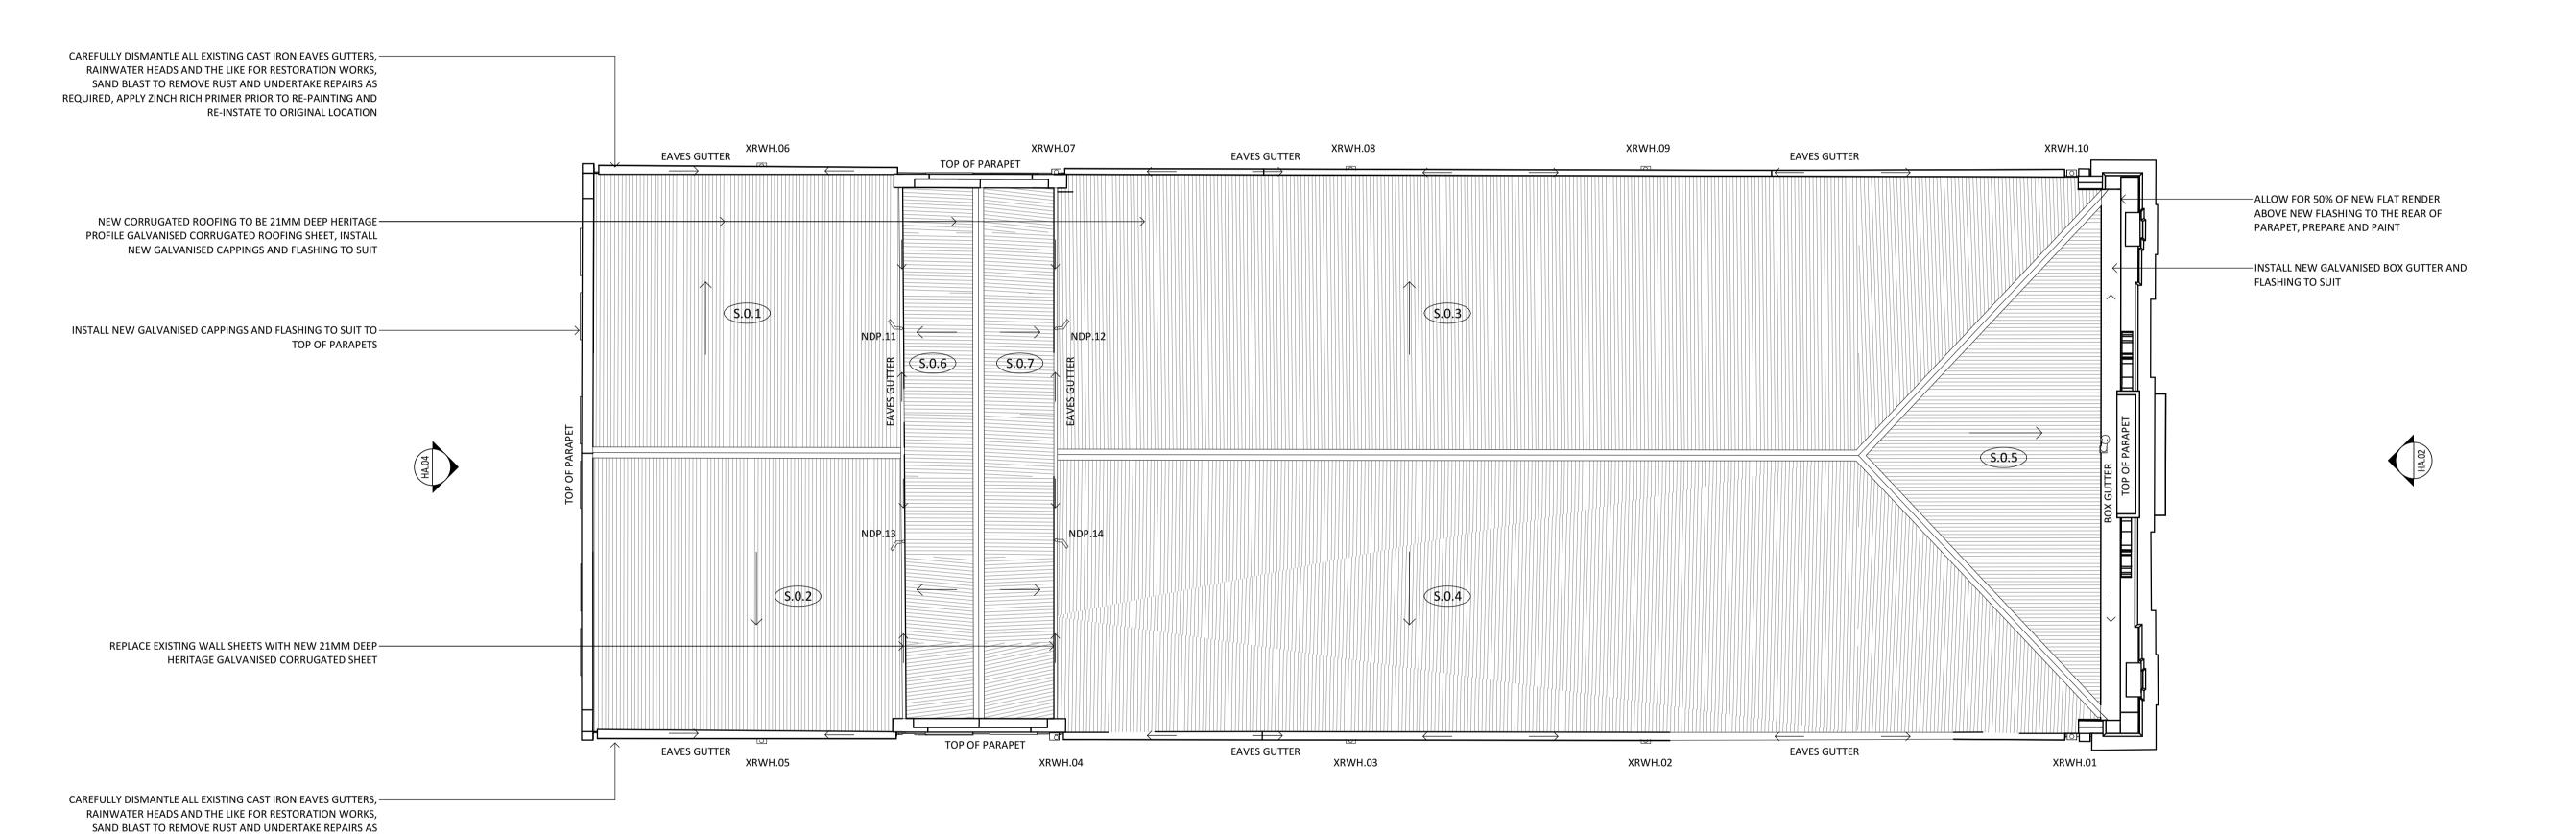
8691 DEC 2020

COVER PAGE AND CONSERVATION METHODS OF REPAIR

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AUTHORITY





REQUIRED, APPLY ZINCH RICH PRIMER PRIOR TO RE-PAINTING AND

RE-INSTATE TO ORIGINAL LOCATION



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- ALL WORK TO COMPLY WITH RELEVANT AUSTRALIAN STANDARDS

ROOF NOTES:

- DEMOLISH EXISTING ROOF ACCESS LADDERS AND WALKWAYS, ROOF SHEETS, DOWNPIPES, BOX GUTTERS AND FLASHING
- 2. DEMOLISH EXISTING TIMBER ROOF STRUCTURE WHERE LIFT
- OVERRUN IS PROPOSED

 3. REMOVE ALL REDUNDANT SERVICES, VENT PIPES AND THE LIKE


 4. PRIOR TO REMOVAL OF CAST IRON GUTTERS AND RAIN WATER
- REINSTATEMENT TO ORIGINAL LOCATION

 5. FULL EXTENT OF GALVAINSED STEEL ROOF SHEETING TO ROOF
 AND LEVEL 6 WALLS TO BE REPLACED WITH NEW 21MM DEEP
 HERITAGE PROFILE GALVANISED CORRUGATED ROOFING SHEET

HEADS RECORD LOCATION OF ELEMENT TO ALLOW FOR

- HERITAGE PROFILE GALVANISED CORRUGATED ROOFING SHEET
 AND INCLUDING ALL FLASHINGS, CAPPINGS AND THE LIKE

 6. INSTALL NEW GLAVANISED STEEL DOWNPIPES TO EXISTING
- LOCATIONS INCLUDING NEW BRACKETS
- PREAPARE AND PAINT GALVAINSED DONWPIPES AND
- BRACKETS TO NORTH AND SOUTH ELEVATION ONLY
- ALLOW FOR THE INSTALLATION OF NEW ROOF ACCESS SYSTEM FOR MAINTENANCE OF ROOF AND GUTTERS

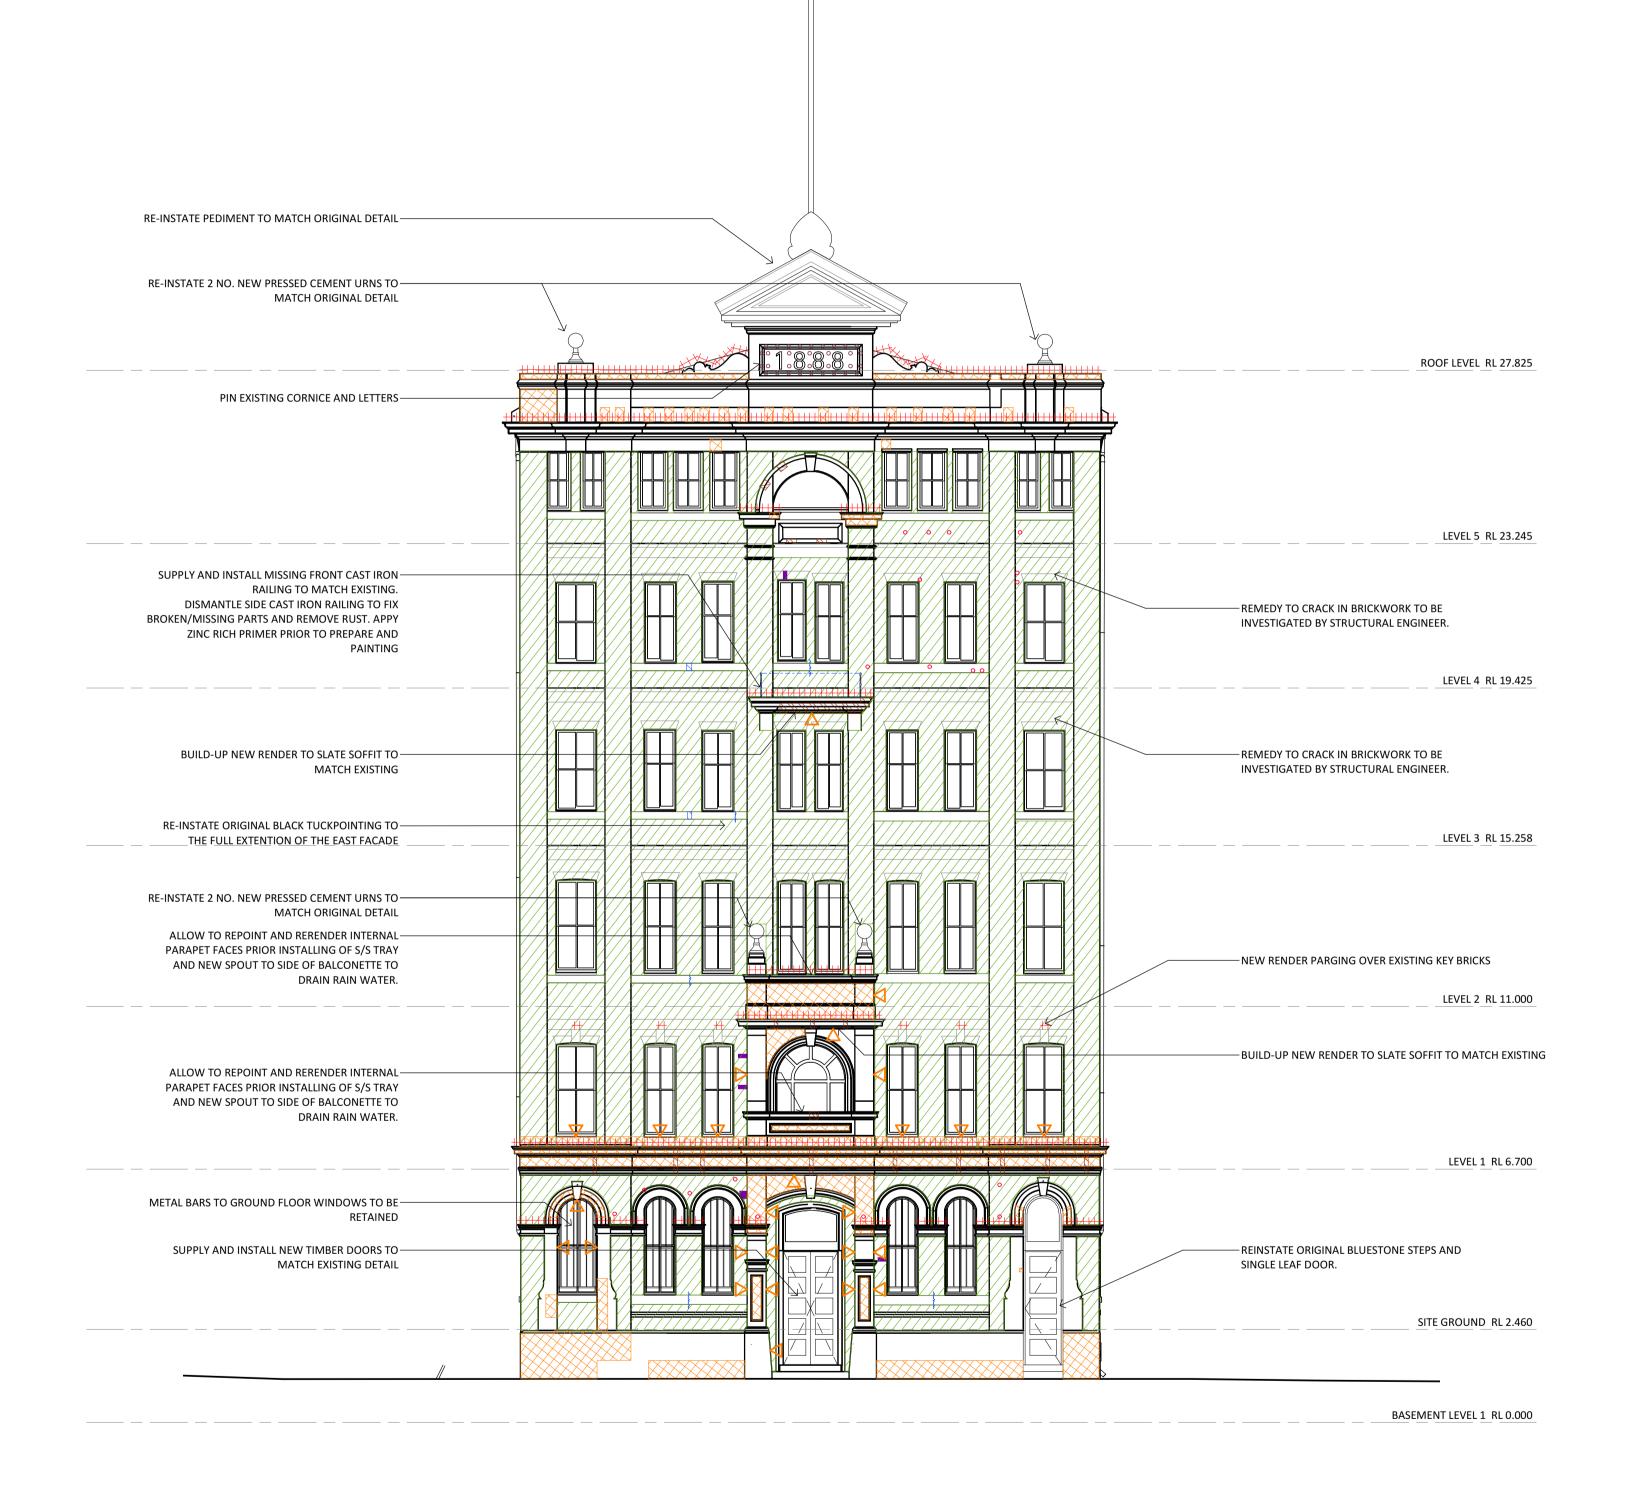

1 PROPOSED EAST ELEVATION /SCALE 1:100

NO.	DATE	REVISION	
P1	18/12/2020	PRELIMINARY - FOR INFORMATION	_
P2	28/01/2021	PRELIMINARY - FOR INFORMATION	
Р3	04/02/2021	PRELIMINARY - FOR INFORMATION	
P4	29/11/2021	PRELIMINARY - FOR INFORMATION	_
P5	02/05/2022	PRELIMINARY - FOR INFORMATION	
P6	01/05/2024	HERITAGE VICTORIA PERMIT APPLICATION	_

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COSTAFOX Suite 102, 54 Davis Avenue, South Yarra VIC 3141

LOVELL CHEN

www.lovelichen.com.au

LEVEL 5, 176 WELLINGTON PARADE

NOT FOR CONSTRUCTION ROBUR TEA BUILDING **28 CLARENDON STREET**

EXTERNAL CONSERVATION WORKS -EAST ELEVATION

NORMANBY RD

KEY PLAN EAST

SCALE 1:500

GENERAL NOTES:

STANDARDS

CONSERVATION WORKS

EXISTING BOND

SCOPE OF WORK

LOCATIONS

WINDOWS

<u>LEGEND</u>

PRIMING AND PAINTING.

GROUND FLOOR WINDOWS

DOCUMENTATION

WORK NOTES:

1. ALL DRAWINGS ARE TO BE READ IN CONJUNCTION WITH

1. REMOVE ALL REDUNDANT SERVICES PRIOR TO UNDERTAKING

3. WHERE NEW OPENINGS ARE NOMINATED BRICKWORK AND BLUESTONE SILLS TO BE CAREFULLY DISMANTLED AND SET

4. EXISTING BRICKWORK TO NEW OPENINGS IS HAVE BOND OF REVEALS REBUILT USING SALVAGED BRICKS, MATCHING

HERITAGE ARCHITECT TO INSPECT SOUTH AND WEST WALLS FOLLOWING THE FULL REMOVAL OF IVY TO CONFIRM EXACT

REMOVE EXISTING FORMED METAL TEA HOUSE SIGN TO THE NORTH AND SOUTH ELEVATIONS, INCLUDING ALL EMBEDDED FIXINGS AND UNDERTAKE RENDER REPAIRS TO FIXING

INCLUDING REMOVAL OF RUST AND FLACKING METAL AS PART OF PREPARATION WORKS PRIOR TO SPOT PRIMING PRIOR TO

7. ALLOW TO PREPARE AND PAINT ALL STEEL FLAT BAR LINTELS,

9. ALLOW TO PREPARE AND PAINT ALL EXISTING METAL VENTS 10. ALLOW TO PREPARE AND PAINT ALL METAL SECURITY BARS TO

11. ALL NEW WINDOWS AND DOORS TO DESIGN ARCHITECT'S

REPLACE DECAYED/DAMAGED/MISSING BRICKWORK

DISMANTLE AND REBUILD BRICKWORK

REPOINT BRICKWORK JOINTS

STONE CRACK REPAIR

INDENT STONE REPAIR REPOINT STONEWORK

COPING/PARCHING

– DEMOLISH

RENDER CRACK REPAIR

PIN PRESSED CEMENT ITEM

REPAIR TYPE / ITEM

CUT OUT AND REPLACE RENDER

RE-RUN SECTION OF MOULDED RENDER

REMOVE EMBEDDED METAL/TIMBER/PLASTIC

DENOTES REPAIR TO RETURN FACE, REFER TO ABOVE REPAIR COLOUR CODINGS FOR RESPECTIVE

SCHEDULE OF CONSERVATION WORKS

ALL REPAIR ITEMS TO BE CROSS REFERENCED WITH

8. ALLOW TO PREPARE AND PAINT ALL EXISTING TIMBER

NEW OPENINGS TO MASONRY WALLS ARE TO BE DISMANTLED

2. ALL WORK TO COMPLY WITH RELEVANT AUSTRALIAN

BY HAND, DO NOT SAW CUT OPENINGS

ASIDE FOR REBUILDING WORKS

DESIGN ARCHITECTS AND ALL CONSULTANTS DOCUMENTATION

DRAWING NO. REVISION **AUTHORITY** 1:100@A1 HA.02 P6

EAST MELBOURNE 3002 AUSTRALIA enquiry@lovelichen.com.au

SOUTHBANK, VIC 3006

DRAWN CHECKED PROJECT NO. DATE SH 8691 DEC 2020

TEL +61 (0)3 9667 0800



LOVELL CHEN

LEVEL 5, 176 WELLINGTON PARADE

TEL +61 (0)3 9667 0800

enquiry@lovelichen.com.au

www.lovelichen.com.au

EAST MELBOURNE 3002 AUSTRALIA

ROBUR TEA BUILDING

28 CLARENDON STREET

SOUTHBANK, VIC 3006

DRAWN CHECKED PROJECT NO. DATE

LT SH 8691 DEC 2020

COSTAFOX

VIC 3141

Suite 102, 54 Davis Avenue, South Yarra

REVISION

P4 29/11/2021 PRELIMINARY - FOR INFORMATION

18/12/2020 PRELIMINARY - FOR INFORMATION

04/02/2021 PRELIMINARY - FOR INFORMATION

02/05/2022 PRELIMINARY - FOR INFORMATION

01/05/2024 HERITAGE VICTORIA PERMIT APPLICATION

PRELIMINARY - FOR INFORMATION

DESIGN ARCHITECT

178 Sturt Street Adelaide, SA 5000

SNØHETTA

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STRUCTURAL ENGINEER

Melbourne VIC 3000

ROBERT BIRD GROUP

4 Collins Square, Level 19/727 Collins St,

GENERAL NOTES:

STANDARDS

WORK NOTES:

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EXTERNAL CONSERVATION WORKS -

DRAWING NO. REVISION


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SOUTH ELEVATION

AUTHORITY

2. ALL WORK TO COMPLY WITH RELEVANT AUSTRALIAN



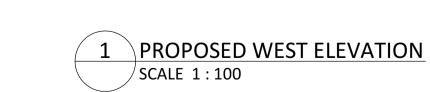

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02/05/2022 PRELIMINARY - FOR INFORMATION

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STRUCTURAL ENGINEER ROBERT BIRD GROUP 4 Collins Square, Level 19/727 Collins St, Melbourne VIC 3000

COSTAFOX Suite 102, 54 Davis Avenue, South Yarra VIC 3141

LOVELL CHEN

TEL +61 (0)3 9667 0800

enquiry@lovelichen.com.au

www.lovelichen.com.au

LEVEL 5, 176 WELLINGTON PARADE EAST MELBOURNE 3002 AUSTRALIA

ROBUR TEA BUILDING **28 CLARENDON STREET**

SOUTHBANK, VIC 3006 DRAWN CHECKED PROJECT NO. DATE

LT SH 8691 DEC 2020

DRAWING TITLE **EXTERNAL CONSERVATION WORKS -WEST ELEVATION**

NORMANBY RD

KEY PLAN WEST

SCALE 1:500

GENERAL NOTES:

STANDARDS

CONSERVATION WORKS

EXISTING BOND

SCOPE OF WORK

PRIMING AND PAINTING.

GROUND FLOOR WINDOWS

DOCUMENTATION

LOCATIONS

WINDOWS

LEGEND

WORK NOTES:

1. ALL DRAWINGS ARE TO BE READ IN CONJUNCTION WITH

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11. ALL NEW WINDOWS AND DOORS TO DESIGN ARCHITECT'S

REPLACE DECAYED/DAMAGED/MISSING BRICKWORK

DISMANTLE AND REBUILD BRICKWORK

REPOINT BRICKWORK JOINTS

STONE CRACK REPAIR

INDENT STONE REPAIR REPOINT STONEWORK

COPING/PARCHING RENDER CRACK REPAIR PIN PRESSED CEMENT ITEM

REPAIR TYPE / ITEM

– DEMOLISH

CUT OUT AND REPLACE RENDER

RE-RUN SECTION OF MOULDED RENDER

REMOVE EMBEDDED METAL/TIMBER/PLASTIC

DENOTES REPAIR TO RETURN FACE, REFER TO ABOVE REPAIR COLOUR CODINGS FOR RESPECTIVE

SCHEDULE OF CONSERVATION WORKS

ALL REPAIR ITEMS TO BE CROSS REFERENCED WITH

8. ALLOW TO PREPARE AND PAINT ALL EXISTING TIMBER

NEW OPENINGS TO MASONRY WALLS ARE TO BE DISMANTLED

2. ALL WORK TO COMPLY WITH RELEVANT AUSTRALIAN

BY HAND, DO NOT SAW CUT OPENINGS

ASIDE FOR REBUILDING WORKS

DESIGN ARCHITECTS AND ALL CONSULTANTS DOCUMENTATION

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GENERAL NOTES:

- 1. ALL DRAWINGS ARE TO BE READ IN CONJUNCTION WITH
- DESIGN ARCHITECTS AND ALL CONSULTANTS DOCUMENTATION
 2. ALL WORK TO COMPLY WITH RELEVANT AUSTRALIAN
 STANDARDS

WORK NOTES:

- 1. REMOVE ALL REDUNDANT SERVICES PRIOR TO UNDERTAKING CONSERVATION WORKS
- 2. NEW OPENINGS TO MASONRY WALLS ARE TO BE DISMANTLED BY HAND, DO NOT SAW CUT OPENINGS
- 3. WHERE NEW OPENINGS ARE NOMINATED BRICKWORK AND BLUESTONE SILLS TO BE CAREFULLY DISMANTLED AND SET
- ASIDE FOR REBUILDING WORKS

 4. EXISTING BRICKWORK TO NEW OPENINGS IS HAVE BOND OF
- REVEALS REBUILT USING SALVAGED BRICKS, MATCHING EXISTING BOND

 HERITAGE ARCHITECT TO INSPECT SOUTH AND WEST WALLS
- FOLLOWING THE FULL REMOVAL OF IVY TO CONFIRM EXACT SCOPE OF WORK

 6. REMOVE EXISTING FORMED METAL TEA HOUSE SIGN TO THE NORTH AND SOUTH ELEVATIONS, INCLUDING ALL EMBEDDED
- LOCATIONS

 7. ALLOW TO PREPARE AND PAINT ALL STEEL FLAT BAR LINTELS, INCLUDING REMOVAL OF RUST AND FLACKING METAL AS PART OF PREPARATION WORKS PRIOR TO SPOT PRIMING PRIOR TO

FIXINGS AND UNDERTAKE RENDER REPAIRS TO FIXING

- PRIMING AND PAINTING.

 8. ALLOW TO PREPARE AND PAINT ALL EXISTING TIMBER
- WINDOWS

 9. ALLOW TO PREPARE AND PAINT ALL EXISTING METAL VENTS

 10. ALLOW TO PREPARE AND PAINT ALL METAL SECURITY BARS TO
- GROUND FLOOR WINDOWS
- 11. ALL NEW WINDOWS AND DOORS TO DESIGN ARCHITECT'S DOCUMENTATION

LEGEND

REPLACE DECAYED/DAMAGED/MISSING BRICKWORK

DISMANTLE AND REBUILD BRICKWORK

REPOINT BRICKWORK JOINTS

CUT OUT AND REPLACE RENDER

RE-RUN SECTION OF MOULDED RENDER

STONE CRACK REPAIR

INDENT STONE REPAIR

REPOINT STONEWORK

O REMOVE EMBEDDED METAL/TIMBER/PLASTIC


COPING/PARCHING

RENDER CRACK REPAIR

PIN PRESSED CEMENT ITEMDEMOLISH

DENOTES REPAIR TO RETURN FACE, REFER TO
ABOVE REPAIR COLOUR CODINGS FOR RESPECTIVE
REPAIR TYPE / ITEM

ALL REPAIR ITEMS TO BE CROSS REFERENCED WITH SCHEDULE OF CONSERVATION WORKS

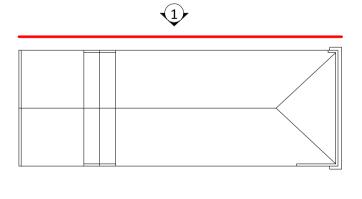

NORMANBY RD



1 PROPOSED NORTH ELEVATION HA.01 SCALE 1:100

NO.	DATE	REVISION
P1	18/12/2020	PRELIMINARY - FOR INFORMATION
P2	28/01/2021	PRELIMINARY - FOR INFORMATION
Р3	04/02/2021	PRELIMINARY - FOR INFORMATION
P4	29/11/2021	PRELIMINARY - FOR INFORMATION
P5	02/05/2022	PRELIMINARY - FOR INFORMATION
P6	01/05/2024	HERITAGE VICTORIA PERMIT APPLICATION

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DESIGN ARCHITECT
SNØHETTA
178 Sturt Street Adelaide, SA 5000

STRUCTURAL ENGINEER

ROBERT BIRD GROUP

4 Collins Square, Level 19/727 Collins St,
Melbourne VIC 3000

COSTAFOX
Suite 102, 54 Davis Avenue, South Yarra
VIC 3141

LOVELL CHEN

LEVEL 5, 176 WELLINGTON PARADE
EAST MELBOURNE 3002 AUSTRALIA
TEL +61 (0)3 9667 0800
enquiry@lovelichen.com.au
www.lovelichen.com.au

PROJECT
ROBUR TEA BUILDING
28 CLARENDON STREET


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SOUTHBANK, VIC 3006


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EXTERNAL CONSERVATION WORKS NORTH ELEVATION

ISSUE SCALE DRAWING NO. REVISION AUTHORITY 1:100@A1 HA.05 P6



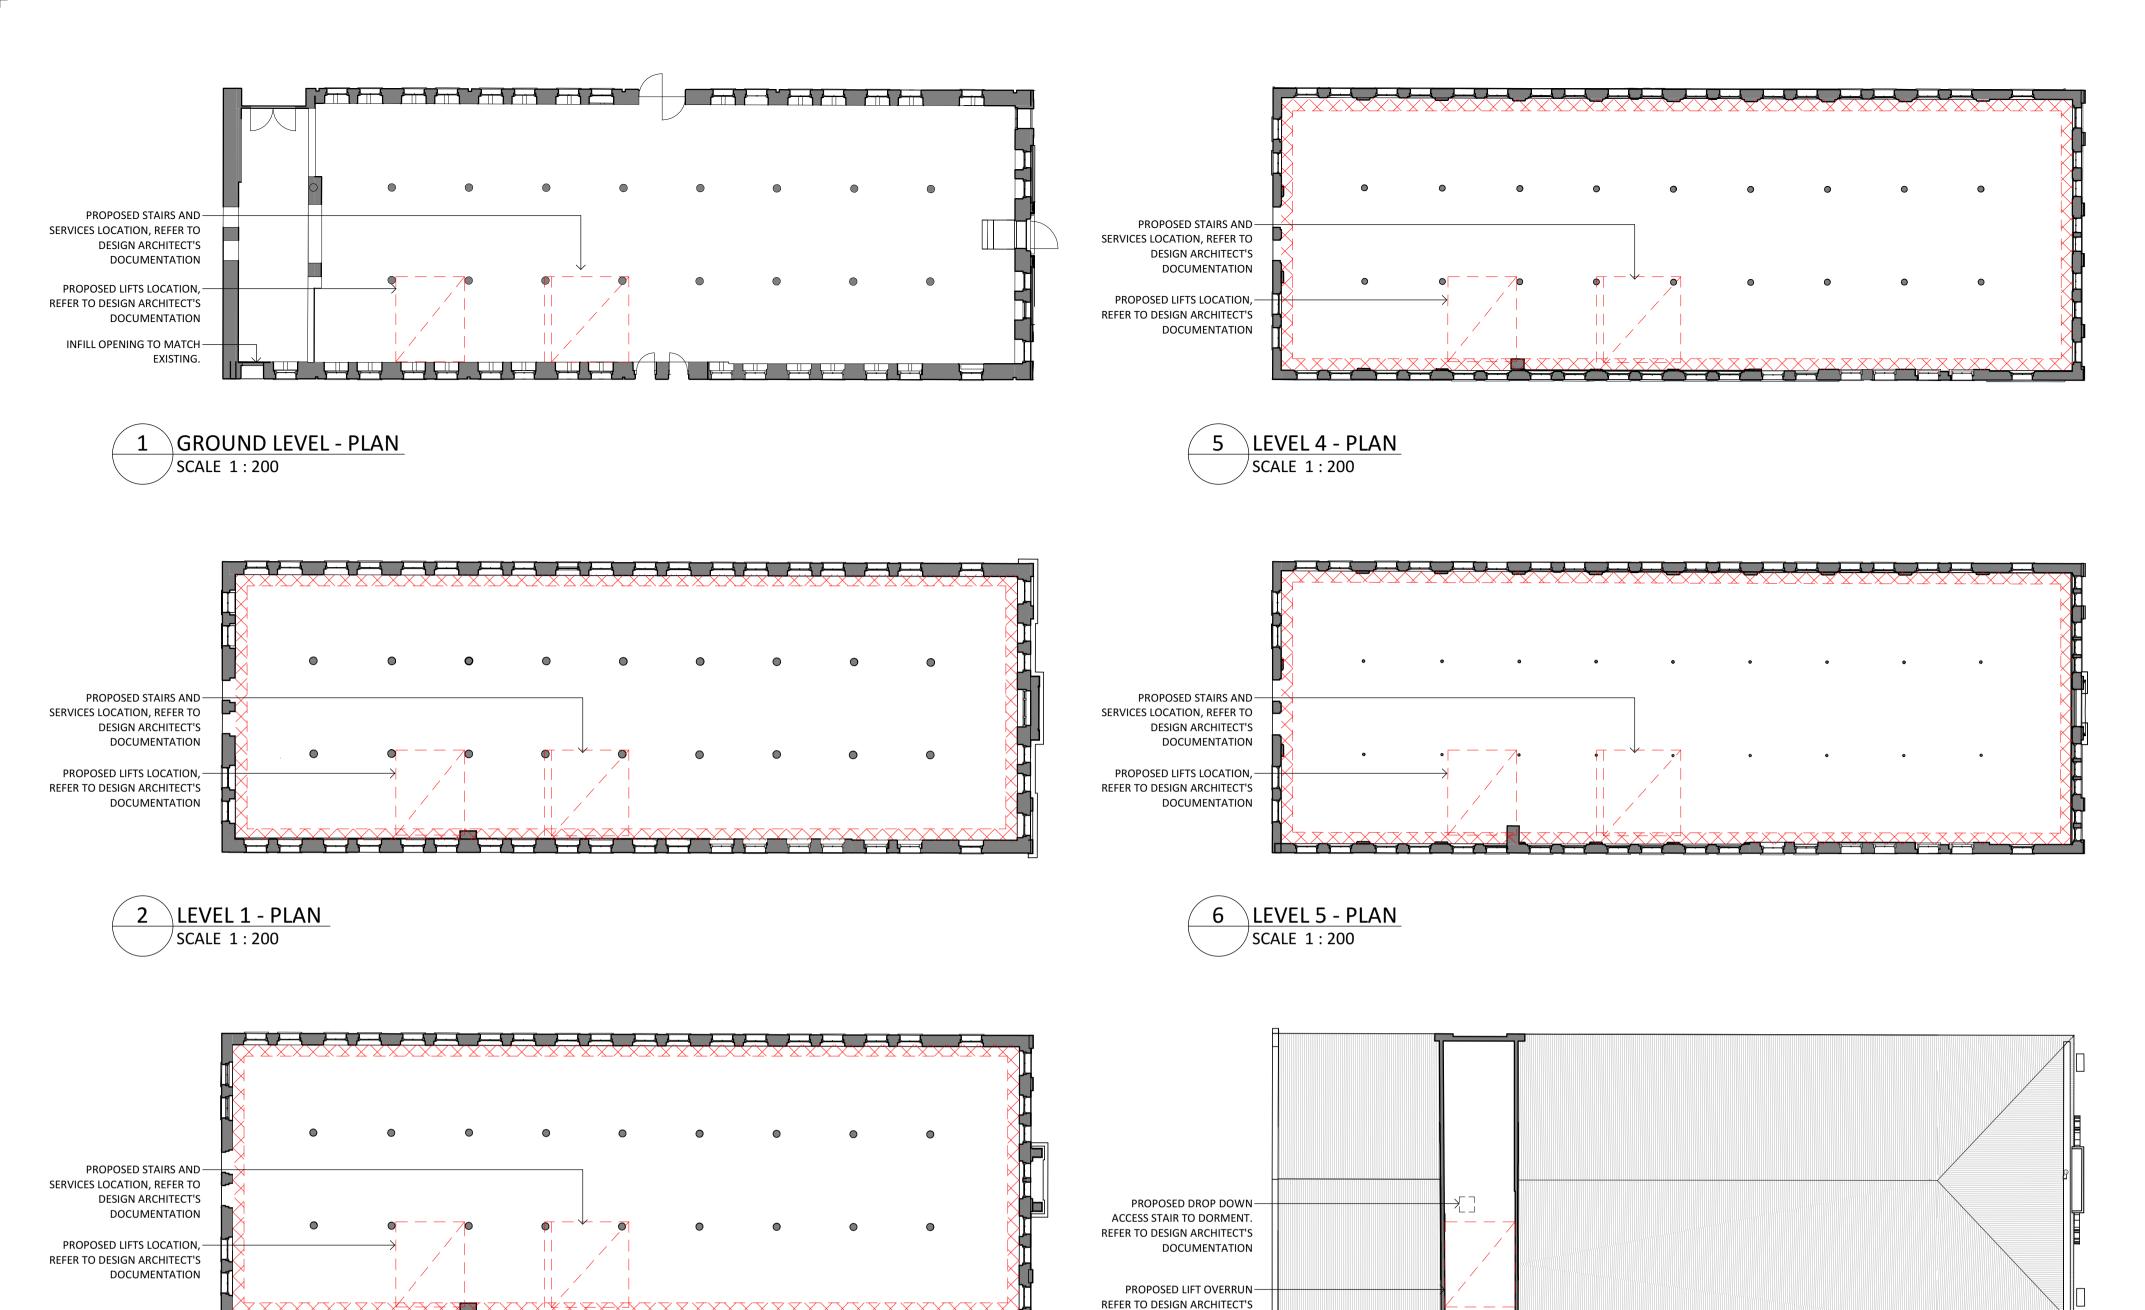

DOCUMENTATION

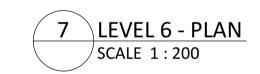INTERIOR CONSERVATION WORKS:

GENERAL WORKS:

- PROTECT EXISTING FABRIC TO BE RETAINED FROM DAMAGE DURING DEMOLITION WORKS INCLUDING BUT NOT LIMITED TO WINDOWS, WALLS, CEILINGS, MASONRY AND FRAMING OR
 - STRUCTURAL ELEMENTS ALL EXISTING BRICKWORK NOMINATED FOR DEMOLITION IS TO BE CAREFULLY DISMANTLED, CLEANED AND PALLETISED FOR REUSE
 - SALVAGE ALL EXISTING TIMBER JOINERY INCLUDING CEILING LINING BOARDS FOR REPAIRS AND REUSE ANY DAMAGED CAUSED DUE TO DEMOLITION WORKS TO BE MADE
- GOOD MATCHING ORIGINAL DETAILS AND MATERIALS PRIOR TO THE REMOVAL OF INFILLS TO OPENINGS ENSURE THERE IS A LINTEL IN PLACE, REFER TO STRUCTURAL ENGINEERS
- DOCUMENTATION FOR DETAILS UNDERTAKE SEISMIC STRENGTHENING WORKS IN ACCORDANCE

WITH STRUCTURAL ENGINEERS DOCUMENTATION

ALL STRENGTHENING TO FLOORS TO BE UNDERTAKEN FROM ABOVE, DO NOT DEMOLISH OR DAMAGE EXISTING LINING BOARD CEILING, ALLOW TO REMOVE SHEET FLOORING TO ENABLE WORKS

GROUND LEVEL WORKS:

- REINSTATE MISSING SECTIONS OF TIMBER LINING BOARD CEILING AND UNDERTAKE REPAIRS TO ORIGINAL TIMBER LINING BOARD CEILING USING SALVAGED BOARDS FROM DEMOLITION WORKS OR NEW BOARDS TO MATCH ORIGINAL THICKNESS AND PROFILE, INCLUDING NEW TIMBER MOULDINGS TO MATCH EXISTING
- ALLOW TO UNDERTAKE REPOINTING WORKS TO 40% OF THE EXISTING BRICKWORK IN ACCORDANCE WITH THE METHOD OF
- ALLOW TO UNDERTAKEN REPAIRS TO BRICKWORK WHERE INTERNAL PARTITION WALLS ABUT BRICKWORK, INCLUDING REMOVAL OF ANY EMBEDDED FIXINGS, REPLACEMENT OF DAMAGED BRICKS AND REPOINTING
- REMOVE ALL EMBEDDED METAL FIXINGS FROM BRICKWORK UNDERTAKEN CHEMICAL PAINT REMOVAL TO BRICKWORK IN THE SOUTH EAST CORNER
- FOLLOWING COMPLETION OF RAINWATER GOODS WORKS, WHERE EFFLORESCENCE EXISTS TO BRICKWORK ON THE SOUTH ELEVATION UNDERTAKE ANALYSIS OF SURFACE SALT TO DETERMINE TREATMENT METHOD AND UNDERTAKE TREATMENT TO DRAW OUT

LEVEL 1 WORKS:

- REINSTATE MISSING SECTIONS OF TIMBER LINING BOARD CEILING AND UNDERTAKE REPAIRS TO ORIGINAL TIMBER LINING BOARD CEILING USING SALVAGED BOARDS FROM DEMOLITION WORKS OR NEW BOARDS TO MATCH ORIGINAL THICKNESS AND PROFILE. INCLUDING NEW TIMBER MOULDINGS TO MATCH EXISTING
- ALLOW TO UNDERTAKE REPOINTING WORKS TO 40% OF THE EXISTING BRICKWORK IN ACCORDANCE WITH THE METHOD OF
- ALLOW TO UNDERTAKEN REPAIRS TO BRICKWORK WHERE INTERNAL PARTITION WALLS ABUT BRICKWORK, INCLUDING REMOVAL OF ANY EMBEDDED FIXINGS, REPLACEMENT OF DAMAGED BRICKS AND REPOINTING
- REMOVE ALL EMBEDDED METAL FIXINGS FROM BRICKWORK
- CUT OUT BROKEN AND DAMAGED BRICKS AND INSTALL SALVAGED BRICKS MATCHING EXISTING BOND REINSTATE FLOOR TO WEST END VOID FOLLOWING REMOVAL OF FIRE STAIR MATCHING ADJACENT FLOOR THICKNESS AND INCLUDING TIMBER LINING BOARD CEILING TO BOTTOM FACE,
- FOLLOWING COMPLETION OF RAINWATER GOODS WORKS, WHERE EFFLORESCENCE EXISTS TO UNDERTAKE ANALYSIS OF SURFACE SALT TO DETERMINE TREATMENT METHOD AND UNDERTAKE TREATMENT TO DRAW OUT SALTS

REFER TO STRUCTURAL ENGINEER FOR ALL STRUCTURAL MEMBER

LEVEL 2 WORKS:

- REINSTATE MISSING SECTIONS OF TIMBER LINING BOARD CEILING AND UNDERTAKE REPAIRS TO ORIGINAL TIMBER LINING BOARD CEILING USING SALVAGED BOARDS FROM DEMOLITION WORKS OR NEW BOARDS TO MATCH ORIGINAL THICKNESS AND PROFILE, INCLUDING NEW TIMBER MOULDINGS TO MATCH EXISTING PROFILES
- ALLOW TO UNDERTAKE REPOINTING WORKS TO 40% OF THE EXISTING BRICKWORK IN ACCORDANCE WITH THE METHOD OF
- ALLOW TO UNDERTAKEN REPAIRS TO BRICKWORK WHERE INTERNAL PARTITION WALLS ABUT BRICKWORK, INCLUDING REMOVAL OF ANY EMBEDDED FIXINGS, REPLACEMENT OF DAMAGED BRICKS AND REPOINTING
- REMOVE ALL EMBEDDED METAL FIXINGS FROM BRICKWORK CUT OUT BROKEN AND DAMAGED BRICKS AND INSTALL SALVAGED
- BRICKS MATCHING EXISTING BOND REINSTATE FLOOR TO WEST END VOID FOLLOWING REMOVAL OF FIRE STAIR MATCHING ADJACENT FLOOR THICKNESS AND
- INCLUDING TIMBER LINING BOARD CEILING TO BOTTOM FACE, REFER TO STRUCTURAL ENGINEER FOR ALL STRUCTURAL MEMBER
- FOLLOWING COMPLETION OF RAINWATER GOODS WORKS, WHERE EFFLORESCENCE EXISTS TO BRICKWORK UNDERTAKE ANALYSIS OF SURFACE SALT TO DETERMINE TREATMENT METHOD AND UNDERTAKE TREATMENT TO DRAW OUT SALTS

LEVEL 3 WORKS:

PROFILES

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- REINSTATE MISSING SECTIONS OF TIMBER LINING BOARD CEILING AND UNDERTAKE REPAIRS TO ORIGINAL TIMBER LINING BOARD CEILING USING SALVAGED BOARDS FROM DEMOLITION WORKS OR NEW BOARDS TO MATCH ORIGINAL THICKNESS AND PROFILE, INCLUDING NEW TIMBER MOULDINGS TO MATCH EXISTING
- ALLOW TO UNDERTAKE REPOINTING WORKS TO 40% OF THE EXISTING BRICKWORK IN ACCORDANCE WITH THE METHOD OF
- ALLOW TO UNDERTAKEN REPAIRS TO BRICKWORK WHERE INTERNAL PARTITION WALLS ABUT BRICKWORK, INCLUDING REMOVAL OF ANY EMBEDDED FIXINGS, REPLACEMENT OF DAMAGED BRICKS AND REPOINTING
- REMOVE ALL EMBEDDED METAL FIXINGS FROM BRICKWORK CUT OUT BROKEN AND DAMAGED BRICKS AND INSTALL SALVAGED

BRICKS MATCHING EXISTING BOND

- REINSTATE FLOOR TO WEST END VOID FOLLOWING REMOVAL OF FIRE STAIR MATCHING ADJACENT FLOOR THICKNESS AND INCLUDING TIMBER LINING BOARD CEILING TO BOTTOM FACE, REFER TO STRUCTURAL ENGINEER FOR ALL STRUCTURAL MEMBER
- FOLLOWING COMPLETION OF RAINWATER GOODS WORKS, WHERE EFFLORESCENCE EXISTS TO BRICKWORK UNDERTAKE ANALYSIS OF SURFACE SALT TO DETERMINE TREATMENT METHOD AND UNDERTAKE TREATMENT TO DRAW OUT SALTS

LEVEL 4 WORKS:

- REINSTATE MISSING SECTIONS OF TIMBER LINING BOARD CEILING AND UNDERTAKE REPAIRS TO ORIGINAL TIMBER LINING BOARD CEILING USING SALVAGED BOARDS FROM DEMOLITION WORKS OR NEW BOARDS TO MATCH ORIGINAL THICKNESS AND PROFILE, INCLUDING NEW TIMBER MOULDINGS TO MATCH EXISTING
- ALLOW TO UNDERTAKE REPOINTING WORKS TO 40% OF THE EXISTING BRICKWORK IN ACCORDANCE WITH THE METHOD OF
- ALLOW TO UNDERTAKEN REPAIRS TO BRICKWORK WHERE INTERNAL PARTITION WALLS ABLIT BRICKWORK INCLUDING REMOVAL OF ANY EMBEDDED FIXINGS, REPLACEMENT OF DAMAGED BRICKS AND REPOINTING
- REMOVE ALL EMBEDDED METAL FIXINGS FROM BRICKWORK CUT OUT BROKEN AND DAMAGED BRICKS AND INSTALL SALVAGED
- BRICKS MATCHING EXISTING BOND REINSTATE FLOOR TO WEST END VOID FOLLOWING REMOVAL OF FIRE STAIR MATCHING ADJACENT FLOOR THICKNESS AND INCLUDING TIMBER LINING BOARD CEILING TO BOTTOM FACE, REFER TO STRUCTURAL ENGINEER FOR ALL STRUCTURAL MEMBER
- FOLLOWING COMPLETION OF RAINWATER GOODS WORKS, WHERE EFFLORESCENCE EXISTS TO BRICKWORK UNDERTAKE ANALYSIS OF SURFACE SALT TO DETERMINE TREATMENT METHOD AND
- UNDERTAKE TREATMENT TO DRAW OUT SALTS ALLOW TO REMOVE CEMENTITIOUS GROUT RESIDUE TO BRICKWORK ON THE WEST AND NORTH ELEVATIONS

LEVEL 5 WORKS:

- ALLOW TO UNDERTAKE REPOINTING WORKS TO 40% OF THE EXISTING BRICKWORK IN ACCORDANCE WITH THE METHOD OF
- ALLOW TO UNDERTAKEN REPAIRS TO BRICKWORK WHERE INTERNAL PARTITION WALLS ABUT BRICKWORK, INCLUDING REMOVAL OF ANY EMBEDDED FIXINGS, REPLACEMENT OF DAMAGED BRICKS AND
- REMOVE ALL EMBEDDED METAL FIXINGS FROM BRICKWORK CUT OUT BROKEN AND DAMAGED BRICKS AND INSTALL SALVAGED
- BRICKS MATCHING EXISTING BOND REINSTATE FLOOR TO WEST END VOID FOLLOWING REMOVAL OF FIRE STAIR MATCHING ADJACENT FLOOR THICKNESS AND
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- EFFLORESCENCE EXISTS TO BRICKWORK UNDERTAKE ANALYSIS OF SURFACE SALT TO DETERMINE TREATMENT METHOD AND UNDERTAKE TREATMENT TO DRAW OUT SALTS
- ALLOW TO REMOVE CEMENTITIOUS GROUT RESIDUE TO BRICKWORK ON THE WEST AND NORTH ELEVATIONS

LEVEL 6 WORKS:

- ALLOW TO UNDERTAKE REPOINTING WORKS TO 20% OF THE EXISTING SOUTH ELEVATION BRICKWORK IN ACCORDANCE WITH THE METHOD OF REPAIR
- CUT OUT BROKEN AND DAMAGED BRICKS TO THE SOUTH **ELEVATION AND INSTALL SALAVAGED BRCIKS MATCHING EXISTING**
- ALLOW TO UNDERTAKEN REPOINTING WORKS TO 10% OF THE EXISTING NORTH ELEVATION BRICKWORK IN ACCORDANCE WITH THE METHOD OF REPAIR
- ALLOW TO UNDERTAKEN REPAIRS TO BRICKWORK WHERE INTERNAL PARTITION WALLS ABUT BRICKWORK, INCLUDING REMOVAL OF ANY EMBEDDED FIXINGS, REPLACEMENT OF DAMAGED BRICKS AND REPOINTING
- REMOVE ALL EMBEDDED METAL FIXINGS FROM BRICKWORK REINSTATE MISSING SECTIONS OF TIMBER LINING BOARD CEILING AND UNDERTAKE REPAIRS TO ORIGINAL TIMBER LINING BOARD CEILING USING SALVAGED BOARDS FROM DEMOLITION WORKS OR NEW BOARDS TO MATCH ORIGINAL THICKNESS AND PROFILE, INCLUDING NEW TIMBER MOULDINGS TO MATCH EXISTING **PROFILES**

DEMOLISH

DEMOLISH FLOOR TO ENABLE SEISMIC STRENGTHEING

NOT FOR CONSTRUCTION

28 CLARENDON STREET SOUTHBANK, VIC 3006 DRAWN CHECKED PROJECT NO. DATE

ROBUR TEA BUILDING

8691 DEC 2020 LT / SH SH enquiry@lovelichen.com.au

DRAWING NO. REVISION **AUTHORITY** As HA.06

indicated@A1

INTERNAL CONSERVATION WORKS

01/05/2024 HERITAGE VICTORIA PERMIT APPLICATION OMISSIONS OR DISCREPANCIES ARE TO BE NOTIFIED TO THE ARCHITECT. COPYRIGHT: THIS DRAWING IS COPYRIGHT AND

3 LEVEL 2 - PLAN

SCALE 1:200

4 LEVEL 3 - PLAN

/ SCALE 1:200

REVISION

04/02/2021 PRELIMINARY - FOR INFORMATION

PRELIMINARY - FOR INFORMATION

PRELIMINARY - FOR INFORMATION

PROPOSED STAIRS AND — SERVICES LOCATION, REFER TO

DESIGN ARCHITECT'S

PROPOSED LIFTS LOCATION,

REFER TO DESIGN ARCHITECT'S

02/05/2022

DOCUMENTATION

DOCUMENTATION

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COSTAFOX Suite 102, 54 Davis Avenue, South Yarra VIC 3141

LEVEL 5, 176 WELLINGTON PARADE EAST MELBOURNE 3002 AUSTRALIA TEL +61 (0)3 9667 0800